

SYMBOL	DATE	DESCRIPTION	BY
		REVISIONS	


© 2015 NORRIS & TUNSTALL

**EROSION CONTROL AND TREE REMOVAL PLAN**  
**PUMP STATION 8 DESIGN**  
 SHIPYARD BOULEVARD  
 NEW HANOVER COUNTY  
 WILMINGTON, N. C.


**OWNER/DEVELOPER**  
 C/P/UA  
 JEFF THEBERGE  
 PROJECT MANAGER  
 235 GOVERNMENT CENTER DR.  
 WILMINGTON, NC 28403  
 910 332-6673

**NORRIS & TUNSTALL**  
**CONSULTING ENGINEERS, P.C.**  
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 WILMINGTON, NC 28401  
 PHONE (910) 343-9653  
 FAX (910) 343-9604  
 nts@norrisandtunstall.com  
 license #C-9361

15048  
 DES. JST  
 CKD. JPN  
 DRWN. NKS  
 DATE 6/28/16

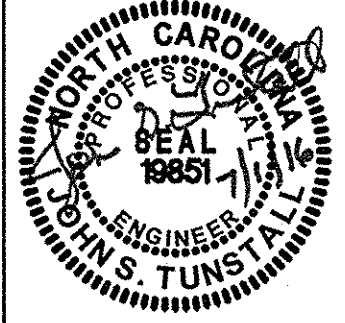


**C1**

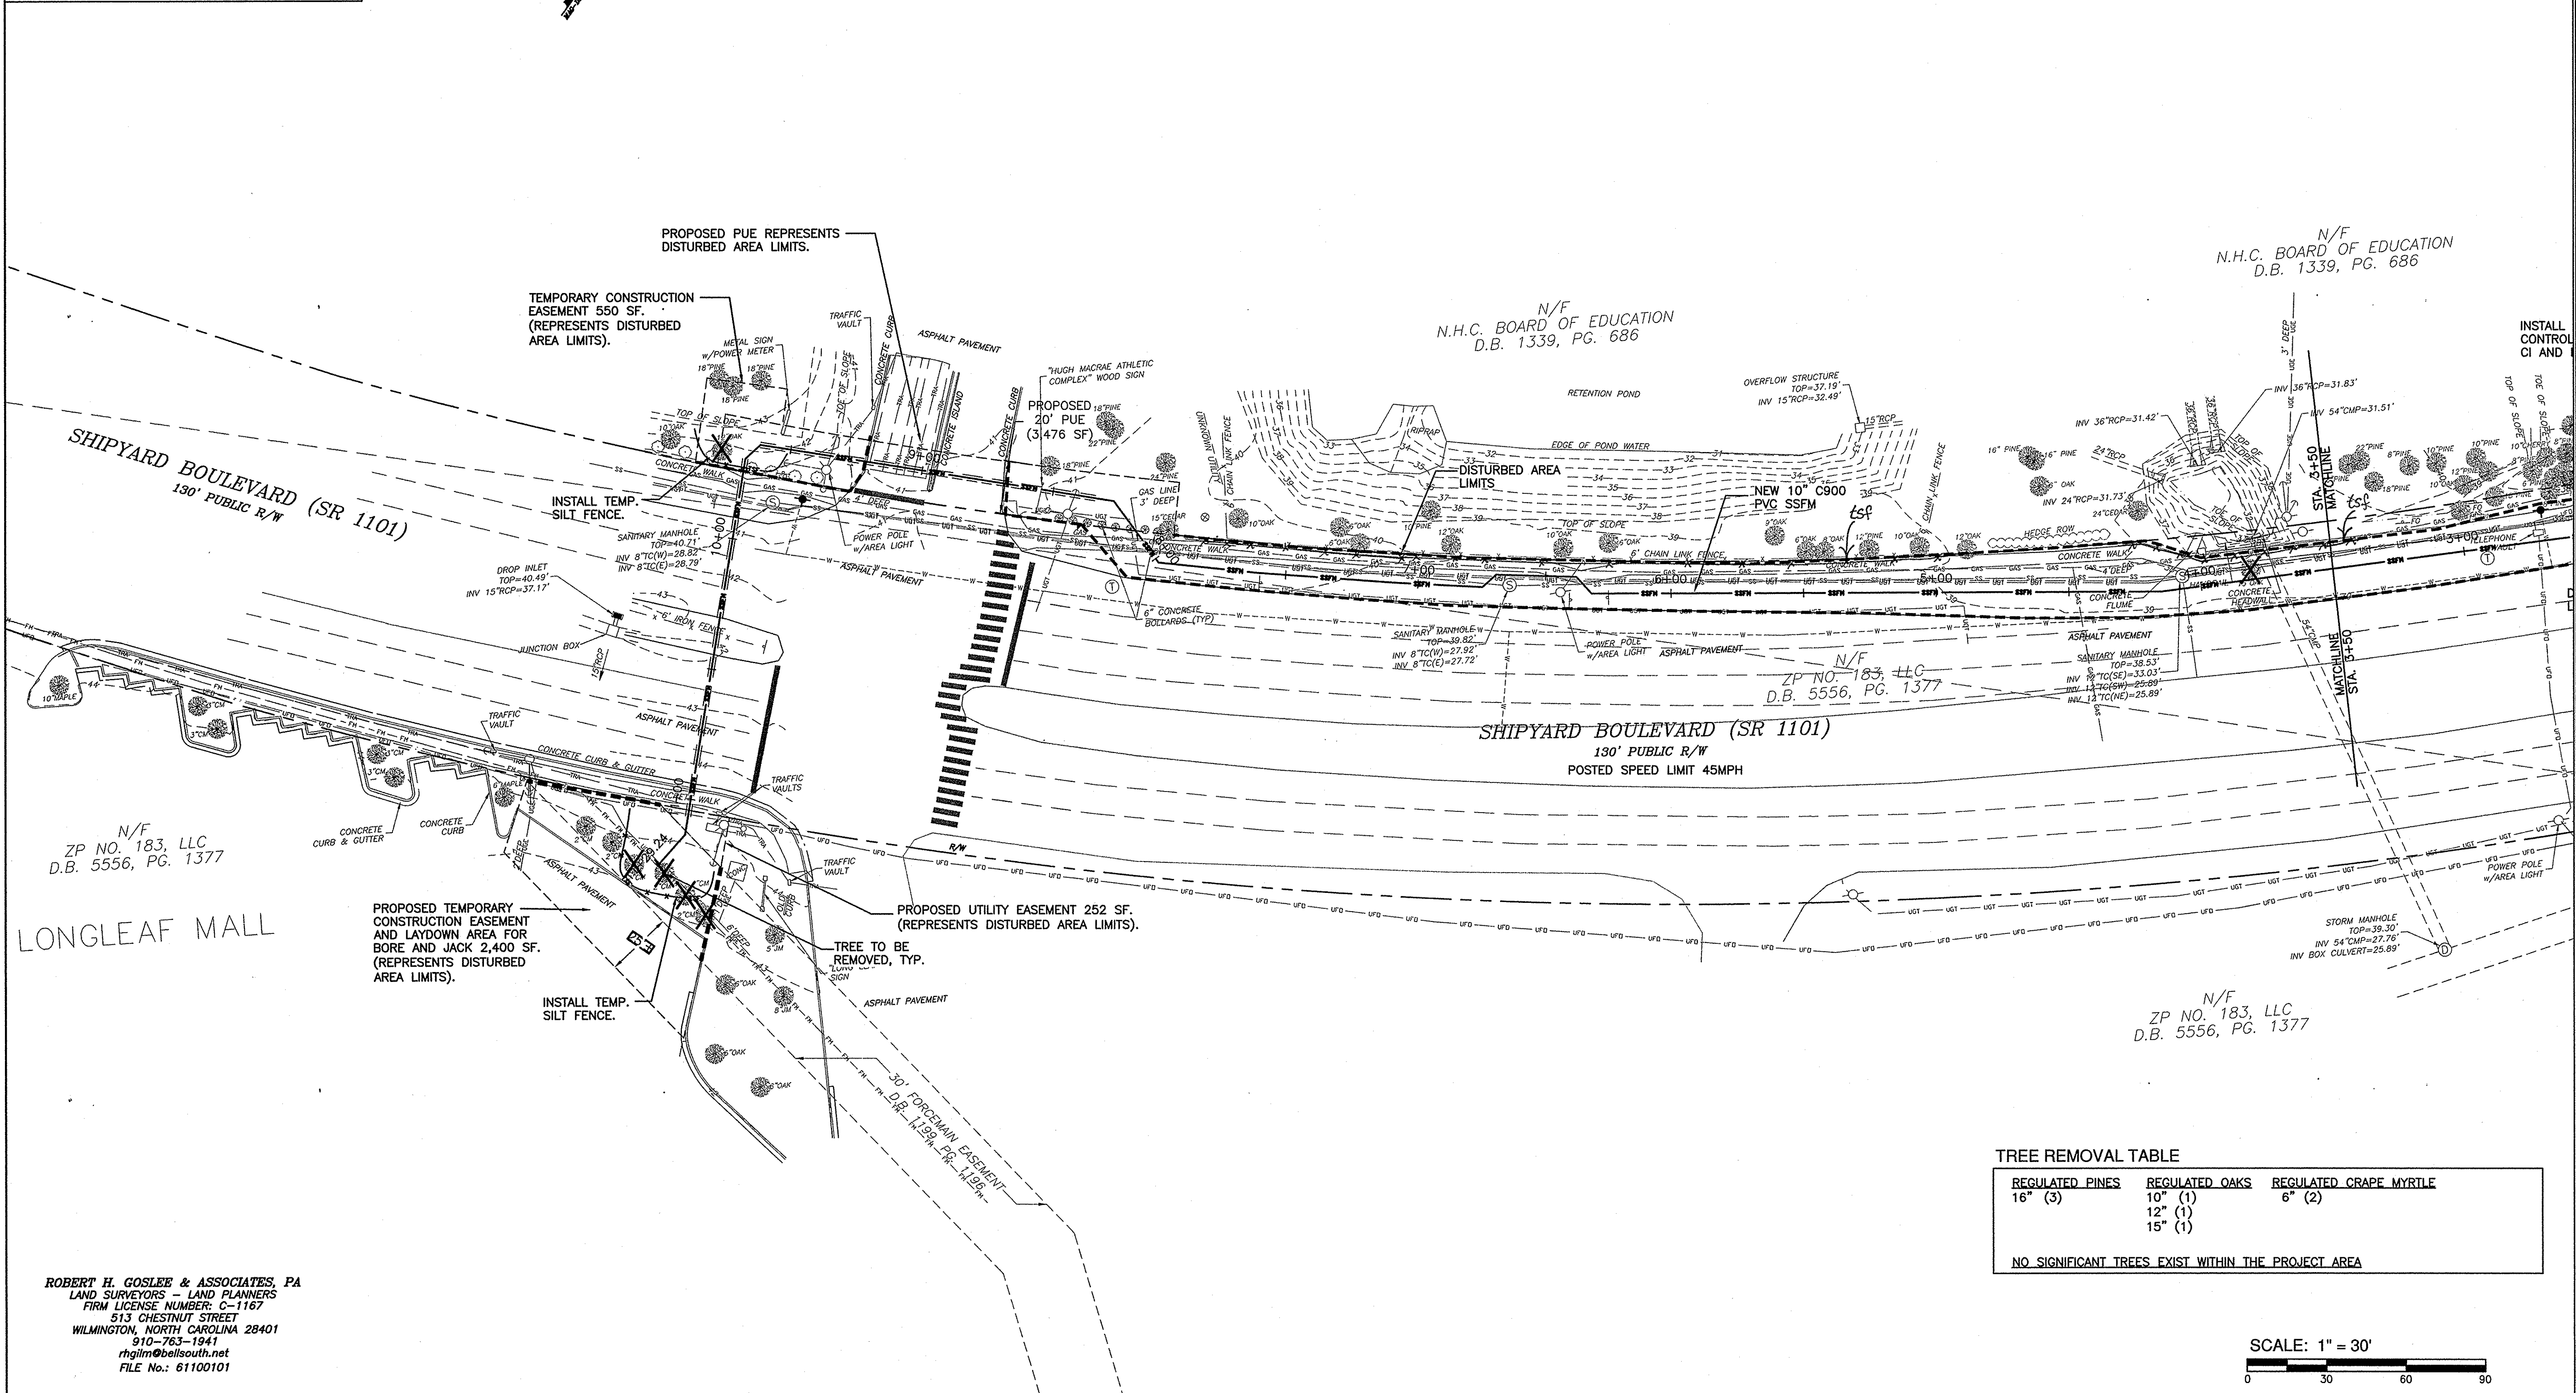

**TREE REMOVAL TABLE**


REGULATED PINES	REGULATED OAKS	REGULATED CRAPE MYRTLE
16" (3)	10" (1)	6" (2)
	12" (1)	
	15" (1)	

NO SIGNIFICANT TREES EXIST WITHIN THE PROJECT AREA


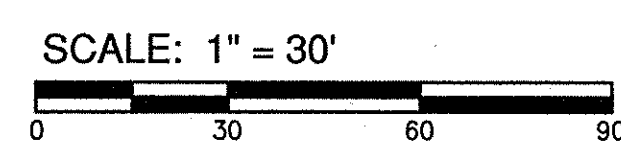


**ROBERT H. GOSLEE & ASSOCIATES, PA**  
 LAND SURVEYORS - LAND PLANNERS  
 FIRM LICENSE NUMBER: C-1167  
 513 CHESTNUT STREET  
 WILMINGTON, NORTH CAROLINA 28401  
 910-763-1941  
 rhgilm@bellsouth.net  
 FILE No.: 61100101

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LOCATION MAP NTS

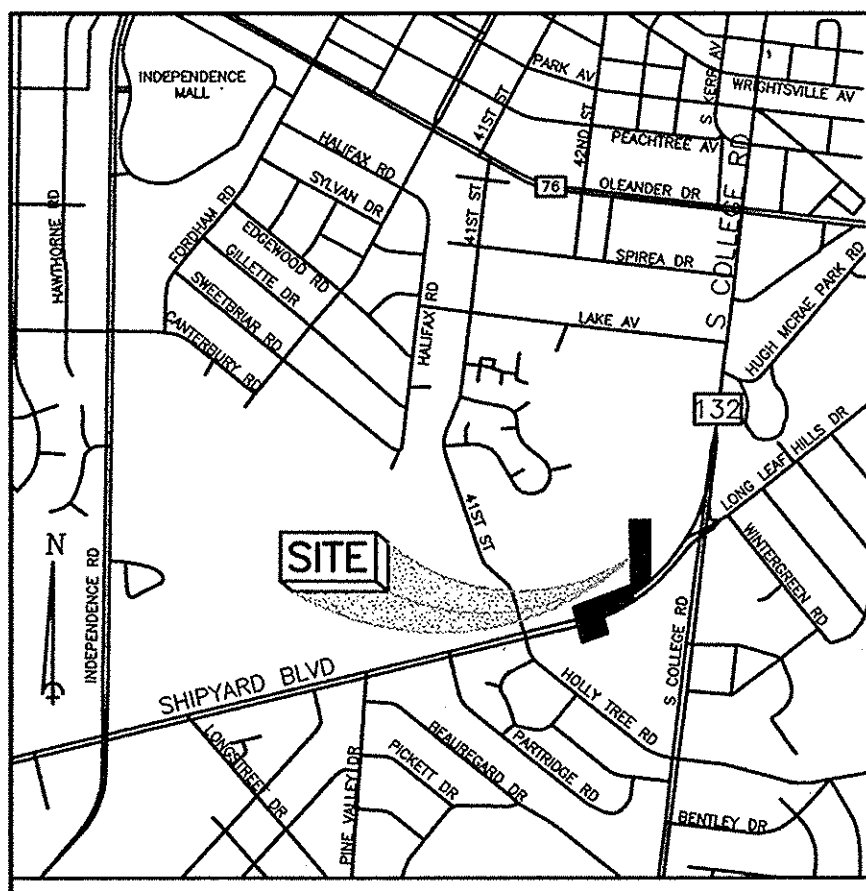


SYMBOL	DATE	DESCRIPTION	BY
		REVISIONS	
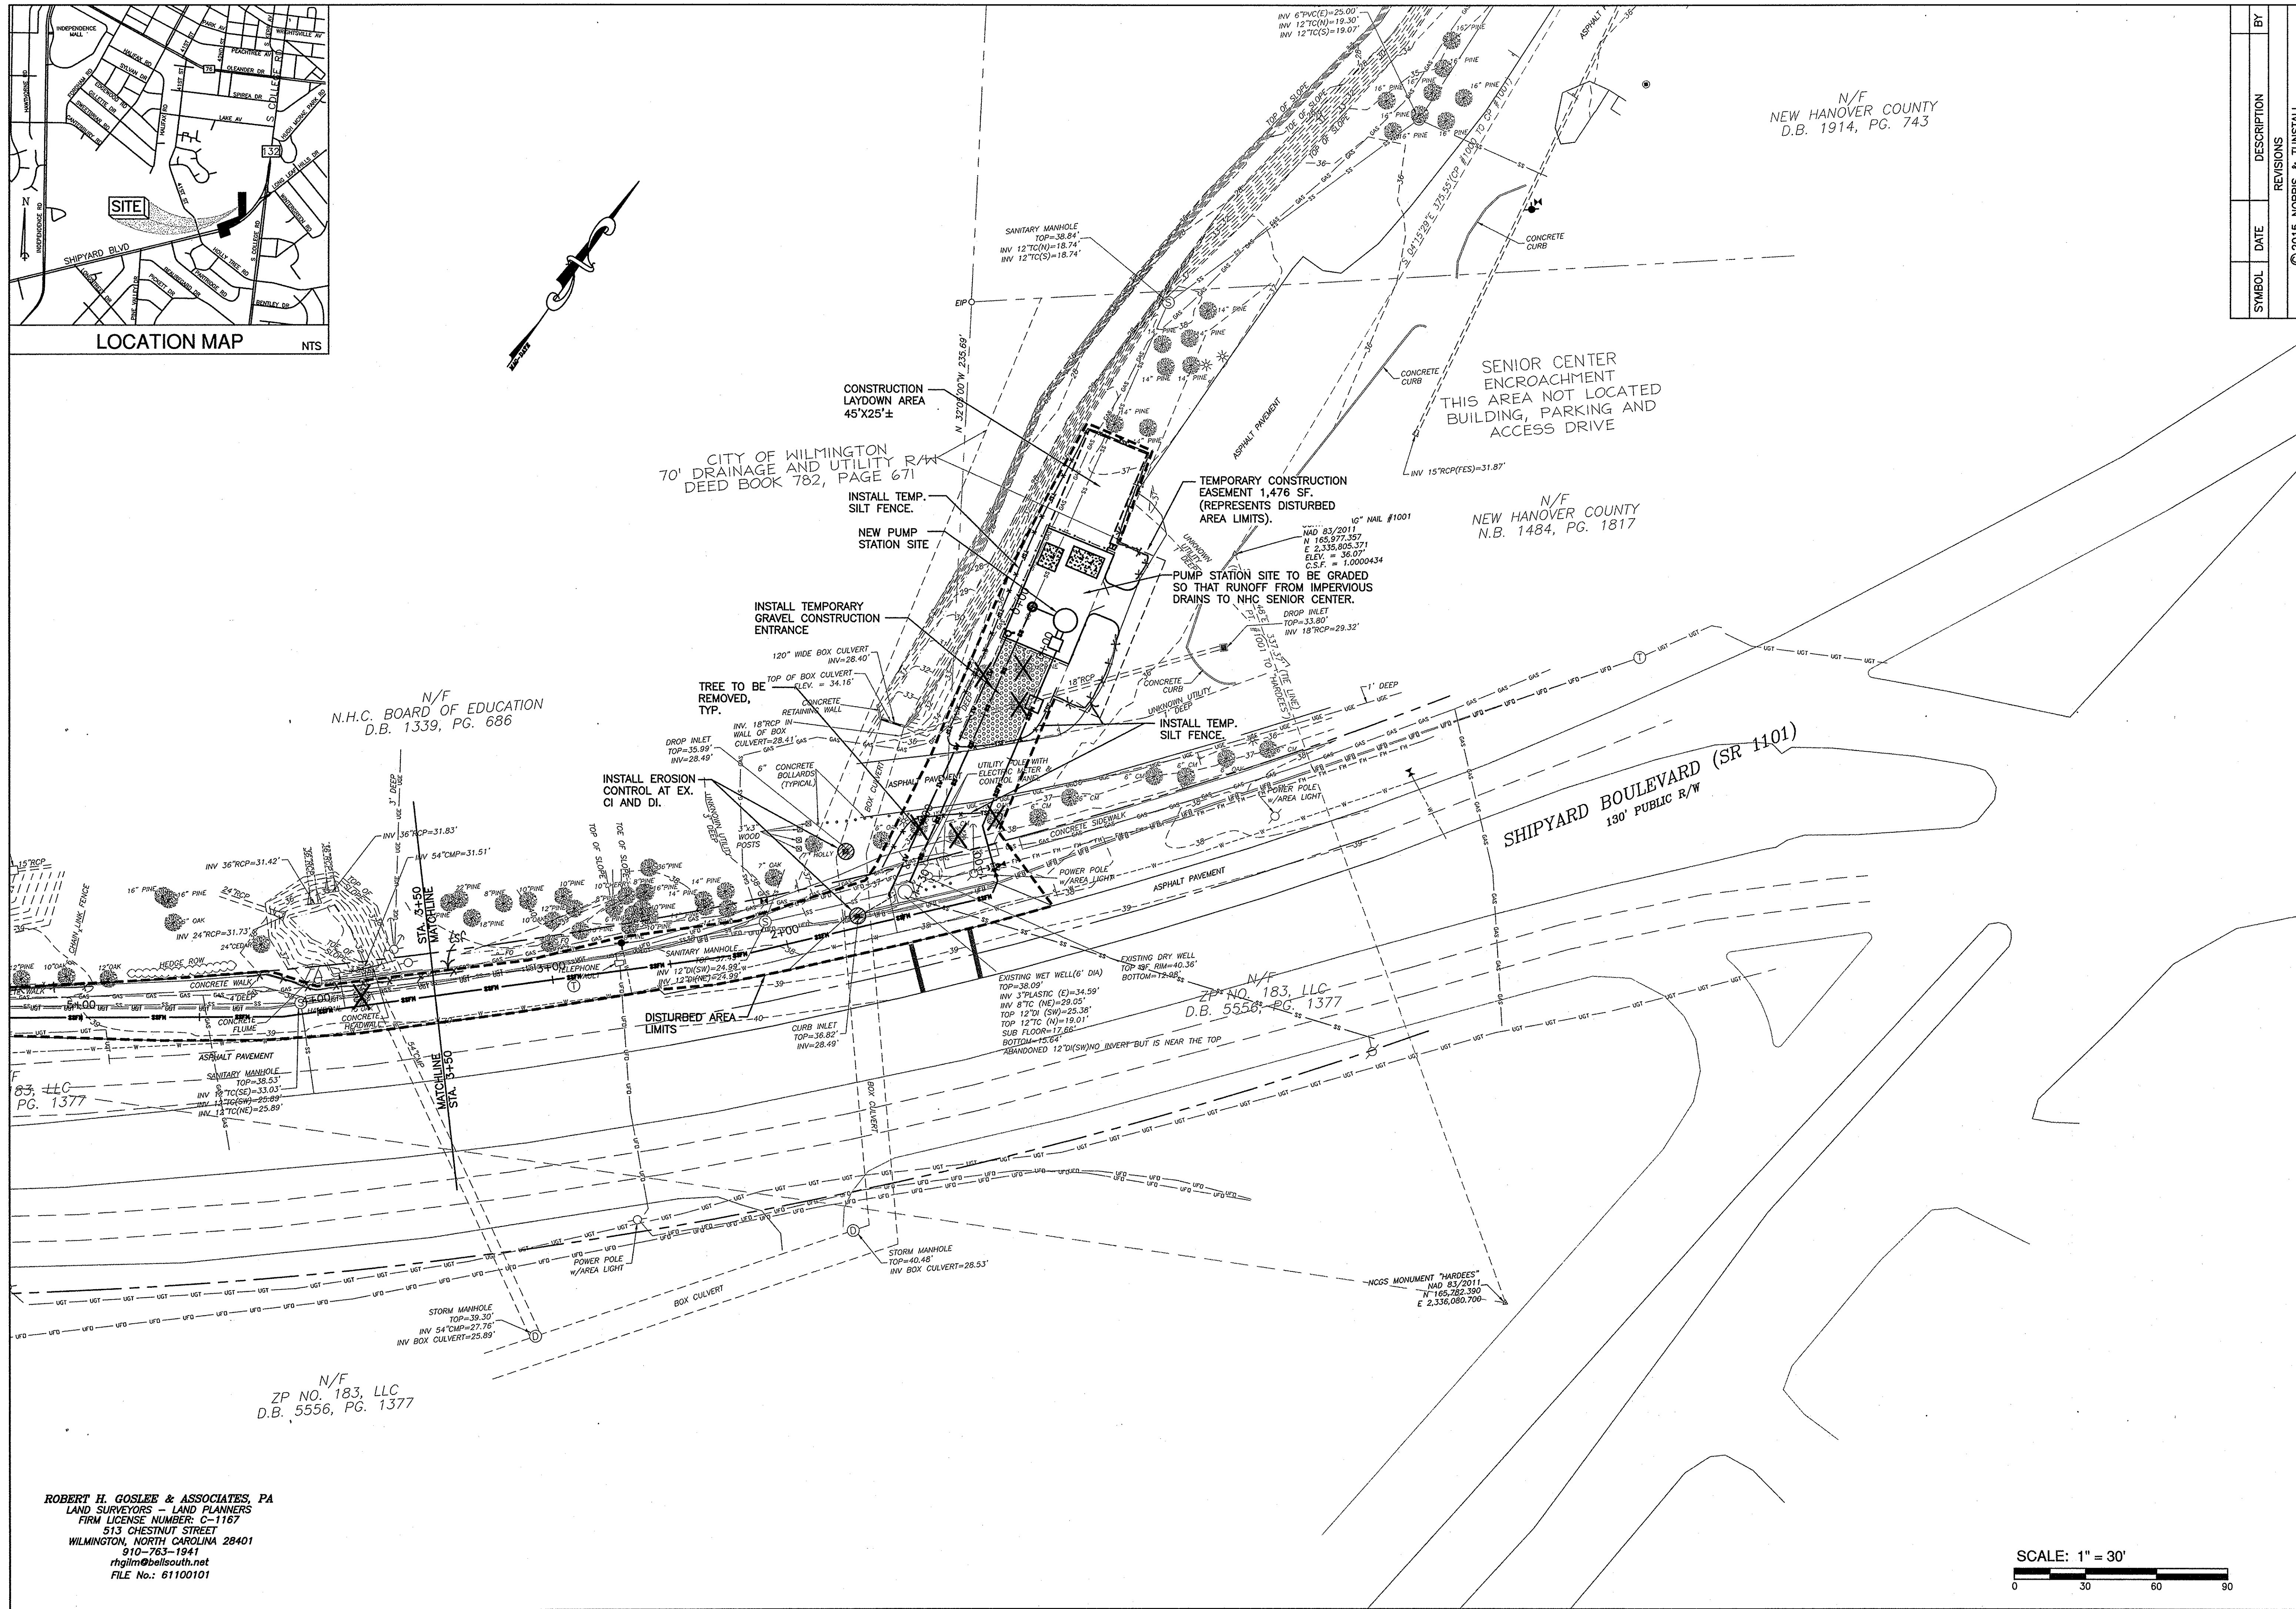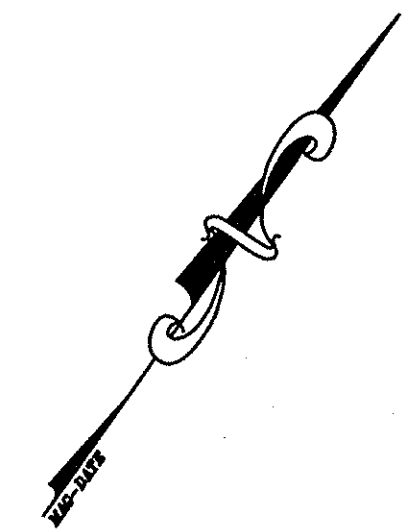
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**EROSION CONTROL AND TREE REMOVAL PLAN**  
**PUMP STATION 8 DESIGN**  
 SHIPYARD BOULEVARD  
 NEW HANOVER COUNTY  
 WILMINGTON, N. C.


**OWNER/DEVELOPER**  
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 910 392-6673

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 902 MARKET STREET  
 WILMINGTON, NC 28401  
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 License # 3611

15048  
 DES. JST  
 CDR. JPN  
 DRWN. NKS  
 DATE 6/28/16

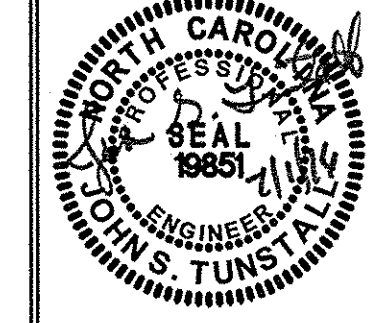

**C2**

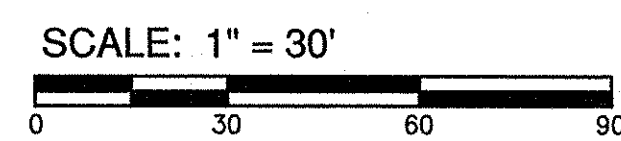

**ROBERT H. GOSLEE & ASSOCIATES, PA**  
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 910-763-1941  
 rhg@rhgllc.com  
 FILE No.: 61100101

N/F  
 ZP NO. 183, LLC  
 D.B. 5556, PG. 1377

N/F  
 N.H.C. BOARD OF EDUCATION  
 D.B. 1339, PG. 686


CITY OF WILMINGTON  
 70' DRAINAGE AND UTILITY R/W  
 DEED BOOK 782, PAGE 671

SHIPYARD BOULEVARD (SR 1101)  
 130' PUBLIC R/W

N/F  
 ZP NO. 183, LLC  
 D.B. 5556, PG. 1377

NCGS MONUMENT "HARDEES"  
 NAD 83/2011  
 N 165.282.350  
 E 2,336,080.700

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NOT TO SCALE

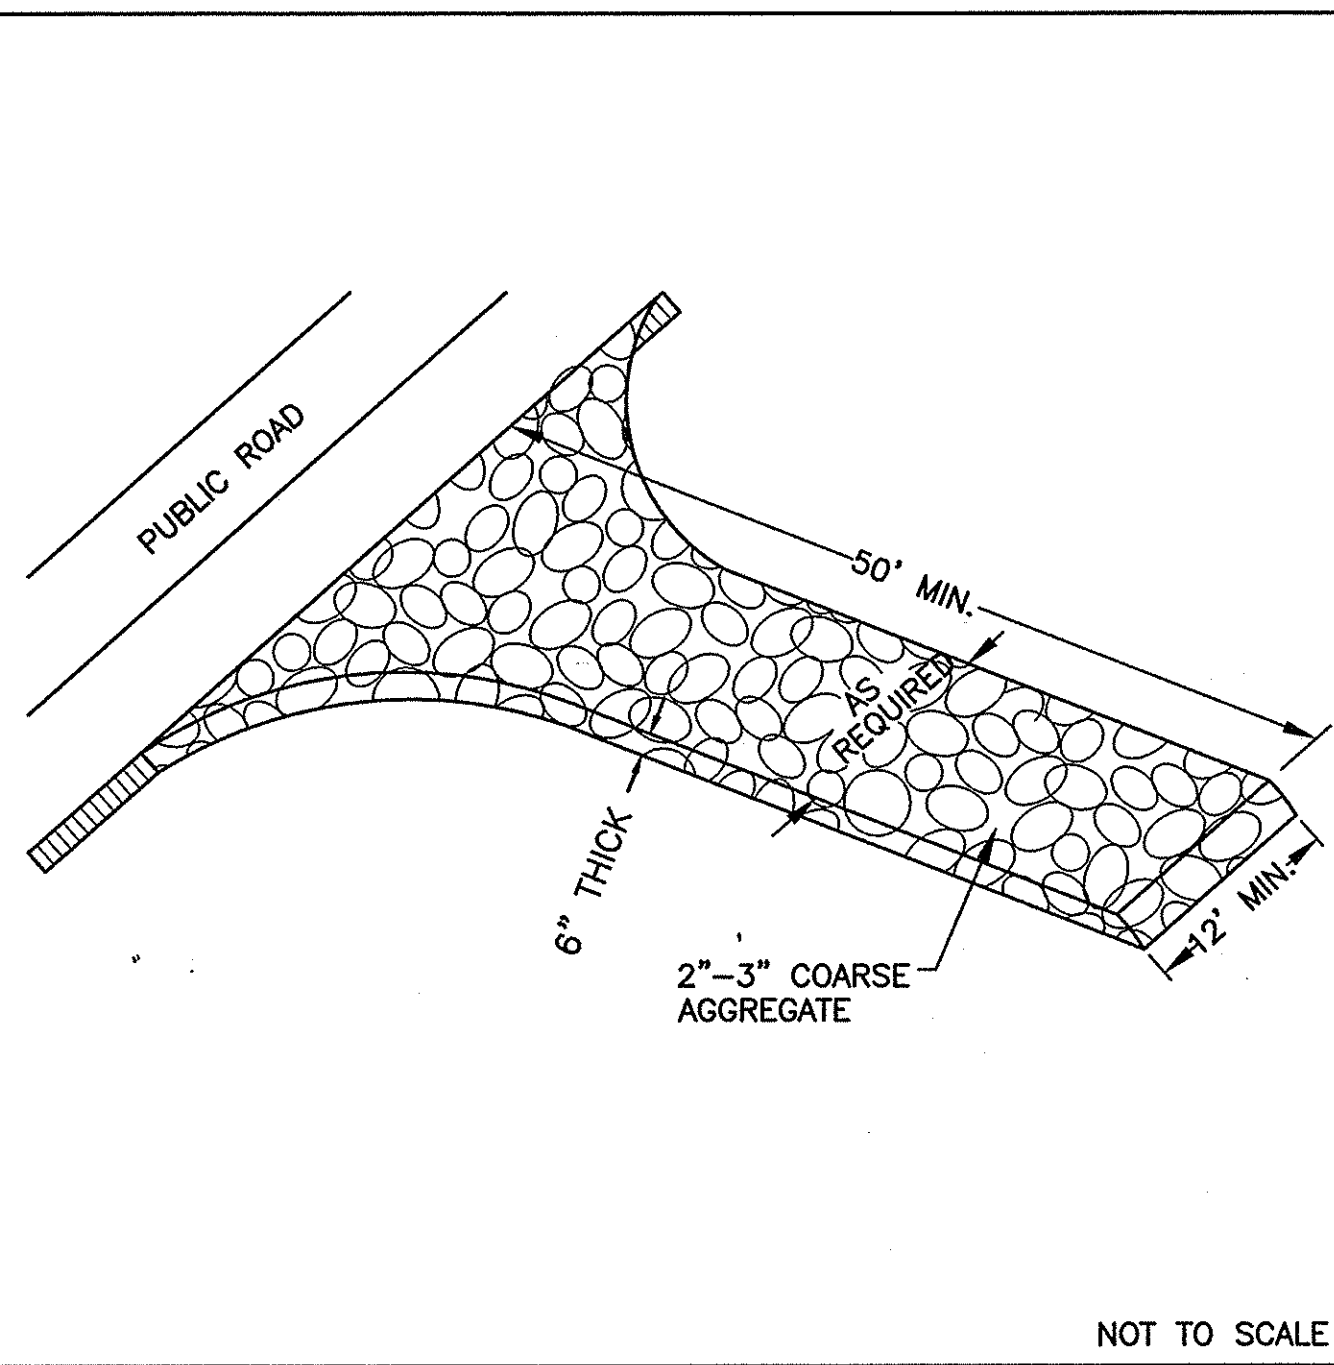1 TEMPORARY GRAVELLED CONSTRUCTION ENTRANCE

2

3 CONSTRUCTION SEQUENCE

**EROSION CONTROL NOTES AND MAINTENANCE PLAN:**


- ALL EROSION AND SEDIMENT CONTROL MEASURES WILL BE CHECKED FOR STABILITY AND OPERATION FOLLOWING EVERY RUNOFF-PRODUCING RAINFALL, BUT IN NO CASE, LESS THAN ONCE EVERY WEEK AND WITHIN 24 HOURS OF EVERY HALF-INCH RAINFALL.
- ALL POINTS OF EGRESS WILL HAVE CONSTRUCTION ENTRANCES THAT WILL BE PERIODICALLY TOP-DRESSED WITH AN ADDITIONAL 2 INCHES OF #4 STONE TO MAINTAIN PROPER DEPTH. THEY WILL BE MAINTAINED IN A CONDITION TO PREVENT MUD OR SEDIMENT FROM LEAVING THE SITE. IMMEDIATELY REMOVE OBJECTIONABLE MATERIAL SPILLED WASHED OR TRACKED ONTO THE CONSTRUCTION ENTRANCE OR ROADWAYS.
- SEDIMENT WILL BE REMOVED FROM HARDWARE CLOTH AND GRAVEL INLET PROTECTION, BLOCK AND GRAVEL INLET PROTECTION, ROCK DOUGHNUT INLET PROTECTION AND ROCK PIPE INLET PROTECTION WHEN THE DESIGNED STORAGE CAPACITY HAS BEEN HALF FILLED WITH SEDIMENT. ROCK WILL BE CLEANED OR REPLACED WHEN THE SEDIMENT POOL NO LONGER DRAINS AS DESIGNED. DEBRIS WILL BE REMOVED FROM THE ROCK AND HARDWARE CLOTH TO ALLOW PROPER DRAINAGE. SLEETS WILL BE CLEANED ONCE A WEEK AND AFTER EVERY RAIN EVENT. SEDIMENT WILL BE REMOVED FROM AROUND WATTLES, BEAVER DAMS, DANDY SACKS AND SOCKS ONCE A WEEK AND AFTER EVERY RAIN EVENT.
- DIVERSION DITCHES WILL BE CLEANED OUT IMMEDIATELY TO REMOVE SEDIMENT OR OBSTRUCTIONS FROM THE FLOW AREA. THE DIVERSION RIDGES WILL ALSO BE REPAIRED. SWALES MUST BE TEMPORARILY STABILIZED WITHIN 21 CALENDAR DAYS OF CEASE OF ANY PHASE OF ACTIVITY ASSOCIATED WITH A SWALE.
- SEDIMENT WILL BE REMOVED FROM BEHIND THE SEDIMENT FENCE WHEN IT BECOMES HALF FILLED. THE SEDIMENT FENCE WILL BE REPAIRED AS NECESSARY TO MAINTAIN A BARRIER. STAKES MUST BE STEEL. STAKE SPACING WILL BE 6 FEET MAX. WITH THE USE OF EXTRA STRENGTH FABRIC, WITHOUT WIRE BACKING. STAKE SPACING WILL BE 8 FEET MAX. WHEN STANDARD STRENGTH FABRIC AND WIRE BACKING ARE USED. IF ROCK FILTERS ARE DESIGNED AT LOW POINTS IN THE SEDIMENT FENCE, THE ROCK WILL BE REPAIRED OR REPLACED IF IT BECOMES HALF-FULL OF SEDIMENT, NO LONGER DRAINS AS DESIGNED OR IS DAMAGED.
- LAND QUALITY REQUIRES:**  
ALL SEEDED AREAS WILL BE FERTILIZED, RESEED AS NECESSARY, AND MULCHED, ACCORDING TO SPECIFICATIONS IN THE VEGETATIVE PLAN, TO MAINTAIN A VIGOROUS, DENSE VEGETATIVE COVER. ALL SLOPES WILL BE STABILIZED WITHIN 21 CALENDAR DAYS. ALL OTHER AREAS WILL BE STABILIZED WITHIN 15 WORKING DAYS.  
**WATER QUALITY REQUIRES:**  
ALL SEEDED AREAS WILL BE FERTILIZED, RESEED AS NECESSARY AND MULCHED ACCORDING TO SPECIFICATIONS IN THE VEGETATIVE PLAN TO MAINTAIN A VIGOROUS, DENSE VEGETATIVE COVER. ALL PERIMETER DIKES, SWALES, DITCHES, PERIMETER SLOPES, ALL SLOPES STEEPER THAN 3' HORIZONTAL TO 1' VERTICAL (3:1) AND ALL HIGH QUALITY WATER (HOW) ZONES SHALL BE PROVIDED TEMPORARY OR PERMANENT STABILIZATION WITH GROUND COVER AS SOON AS PRACTICABLE BUT IN ANY EVENT WITHIN SEVEN (7) CALENDAR DAYS FROM THE LAST LAND-DISTURBING ACTIVITY. ALL OTHER DISTURBED AREAS SHALL BE PROVIDED TEMPORARY OR PERMANENT STABILIZATION WITH GROUND COVER AS SOON AS PRACTICABLE BUT IN ANY EVENT WITHIN FOURTEEN (14) CALENDAR DAYS FROM THE LAST LAND-DISTURBING ACTIVITY.

**SITE WORK NOTES:**

- THE CONTRACTOR SHALL VISIT THE SITE TO BECOME FAMILIAR WITH FIELD CONSTRUCTION CONDITIONS.
- CONTRACTOR SHALL COORDINATE WORK WITH NCDOT AND LOCAL RIGHT OF WAYS WITH PROPER AUTHORITIES AND SHALL MEET ANY REQUIREMENTS AS TO TRAFFIC CONTROL AND CONNECTION TO EXISTING STREETS.
- EARTH WORK AND GRADING: SEE PROJECT SPECIFICATIONS.
- LAYOUT: THE CONTRACTOR SHALL PROVIDE ALL LAYOUT REQUIRED TO CONSTRUCT HIS WORK.
- THE CONTRACTOR IS RESPONSIBLE FOR THE LOCATION AND PROTECTION OF EXISTING UTILITIES DURING CONSTRUCTION.
- EXISTING BOUNDARY AND TOPOGRAPHIC INFORMATION FROM SURVEY BY ROBERT H. GOSLEE AND ASSOC. AND PROVIDED BY OWNER.
- THE CONTRACTOR SHALL VERIFY DIMENSIONS AT JOBSITE.
- THE CONTRACTOR IS RESPONSIBLE FOR THE COORDINATION OF RELOCATION OR DISCONNECTION OF ALL EXISTING UTILITIES WITH APPLICABLE AGENCIES AND AUTHORITIES.
- ALL PAVEMENT AND BASE MATERIALS AND WORKMANSHIP SHALL CONFORM TO NCDOT STANDARDS.
- ALL AREAS SHALL BE GRADED FOR POSITIVE DRAINAGE.
- SEE SOILS REPORT FOR ADDITIONAL REQUIREMENTS.

**NOTES AND DETAILS**  
PUMP STATION 8 DESIGN  
SHIPYARD BOULEVARD  
NEW HANOVER COUNTY  
WILMINGTON, N. C.

**OWNER/DEVELOPER**  
CFFUA  
JEFF THERBERGE  
PROJECT MANAGER  
235 GOVERNMENT CENTER DR.  
WILMINGTON, NC 28403  
910 332-6673

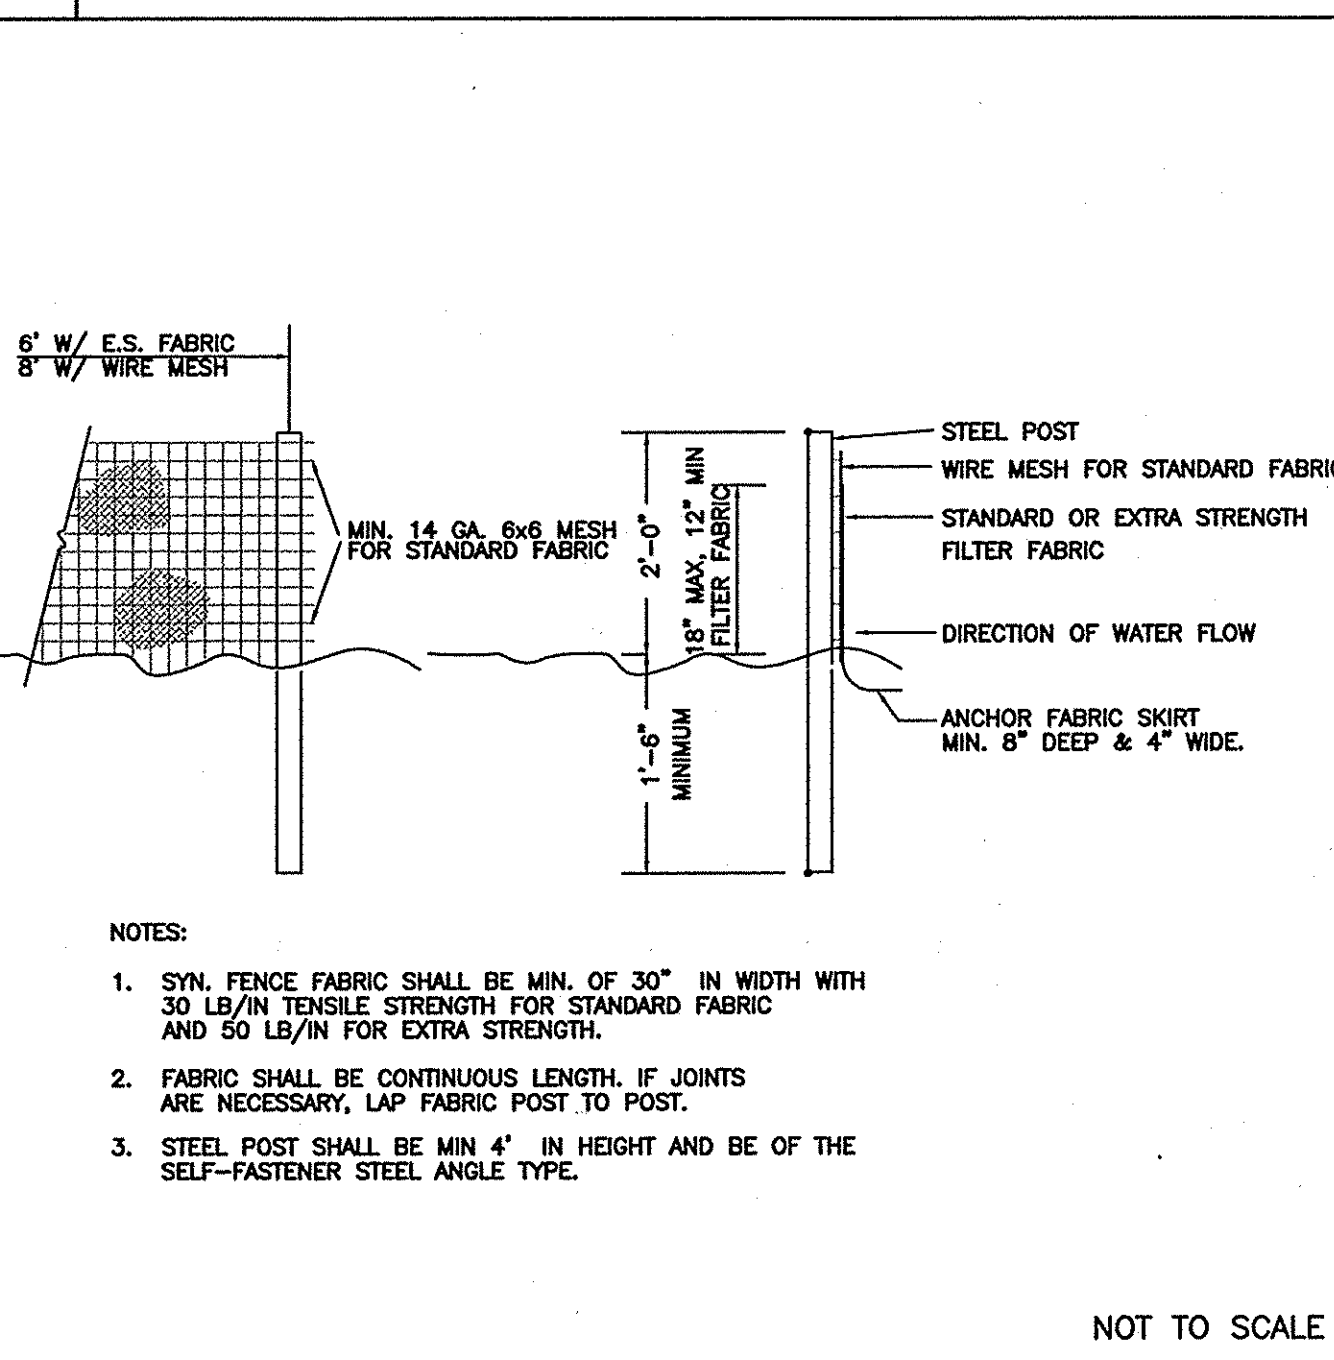

NOT TO SCALE

4 TEMPORARY SILT FENCE

5


6

**TEMPORARY/PERMANENT GRASS SPECIFICATION:**

- CHISEL COMPACTED AREAS AND SPREAD TOPSOIL 3 INCHES DEEP OVER ADVERSE SOIL CONDITIONS.
- RIP THE ENTIRE AREA TO A 6 INCH DEPTH.
- REMOVE ALL ROCKS, ROOTS AND OTHER OBSTRUCTIONS LEAVING SURFACES SMOOTH AND UNIFORM.
- APPLY AGRICULTURAL LIME AND FERTILIZER UNIFORMLY AND MIX WITH SOIL.  
LIME: 45 LBS. PER 1000 S.F.  
PHOSPHORUS: 20 LBS PER 1000 S.F.  
FERTILIZER: 17 LBS. PER 1000 S.F.
- CONTINUE TILLAGE UNTIL A WELL PULVERIZED, FIRM, UNIFORM SEED BED IS PREPARED 4-6 INCHES DEEP.
- SEED ON A FRESHLY PREPARED SEED BED AND COVER SEED LIGHTLY.  
2 - 3 LBS PER 1000 S.F. (SEE MIXTURE BELOW)
- MULCH IMMEDIATELY AFTER SEEDING AND ANCHOR MULCH.  
GRAIN STRAW & HAY AT 75 TO 100 LBS PER 1000 S.F.  
WOOD CHIPS AT 500 LBS. PER 1000 S.F.  
JUTE & MESH AS PER MANUFACTURER
- ASPHALT FOR ANCHORING MULCH SHALL BE TYPE SS-1 EMULSION AND APPLIED AT A RATE OF 1000 GAL. PER ACRE FOR SLOPE STABILIZATION, AND 150 GAL. PER TON OF STRAW FOR ANCHORING STRAW.
- INSPECT ALL SEEDED AREAS AND MAKE NECESSARY REPAIRS OR RESEED WITHIN THE PLANTING SEASON, IF POSSIBLE. IF GRASS STAND SHOULD BE OVER 60% DAMAGED, REESTABLISH FOLLOWING ORIGINAL LIME, FERTILIZER AND SEEDING RATES.
- CONSULT CONSERVATION INSPECTOR ON MAINTENANCE, TREATMENT, AND FERTILIZATION AFTER PERMANENT COVER IS ESTABLISHED.
- SEED FOR TEMPORARY AND PERMANENT APPLICATIONS SHALL BE:  
20% CARPET GRASS  
28% BERMUDA GRASS  
20% TURF FESCUE  
10% CREEPING RED FESCUE  
20% ANNUAL RYE GRASS  
\*BERMUDA SEED SHALL BE HULLED FOR WARM WEATHER PLANTING. PURITY OF SEED SHALL BE A MIN. OF 98% AND GERMINATION SHALL BE A MIN. OF 85%.  
ALL DISTURBED AREA SHALL BE SEEDED WITHIN 7-14 DAYS OF THE COMPLETION OF GRADING. SEE EROSION CONTROL AND MAINTENANCE NOTES. CONSULT CONSERVATION ENGINEER OR SOIL CONSERVATION SERVICE FOR ADDITIONAL INFORMATION CONCERNING OTHER ALTERNATIVES FOR VEGETATION OF DENUDEED AREAS. THE ABOVE VEGETATION RATES ARE THOSE WHICH DO WELL UNDER LOCAL CONDITIONS, OTHER SEEDING SCHEDULES MAY BE POSSIBLE.

**CALL 811 (3) WORKING DAYS BEFORE YOU DIG.**

For each open utility cut of City streets, a \$325 permit shall be required from the City prior to occupancy and/or project acceptance.

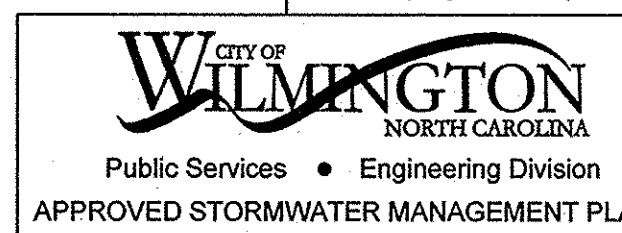

APPROVED STORMWATER MANAGEMENT PLAN  
Date: \_\_\_\_\_ Permit # \_\_\_\_\_  
Signed: \_\_\_\_\_


Approved Construction Plan  
Name \_\_\_\_\_ Date \_\_\_\_\_

Planning \_\_\_\_\_  
Traffic \_\_\_\_\_  
Fire \_\_\_\_\_


**NORRIS & TUNSTALL**  
CONSULTING ENGINEERS, P.C.  
802 MARKET STREET  
WILMINGTON, NC 28401  
PHONE (910) 343-9653  
FAX (910) 343-9604  
license #12-9341

15048  
DES. JST  
C.D. JPN  
DRWL. NKS

DATE 6/28/16

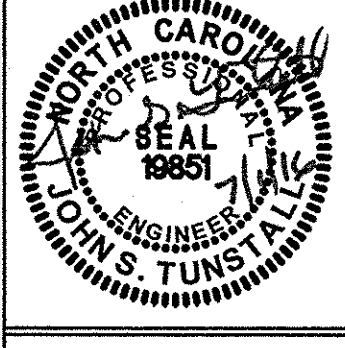


**C3**

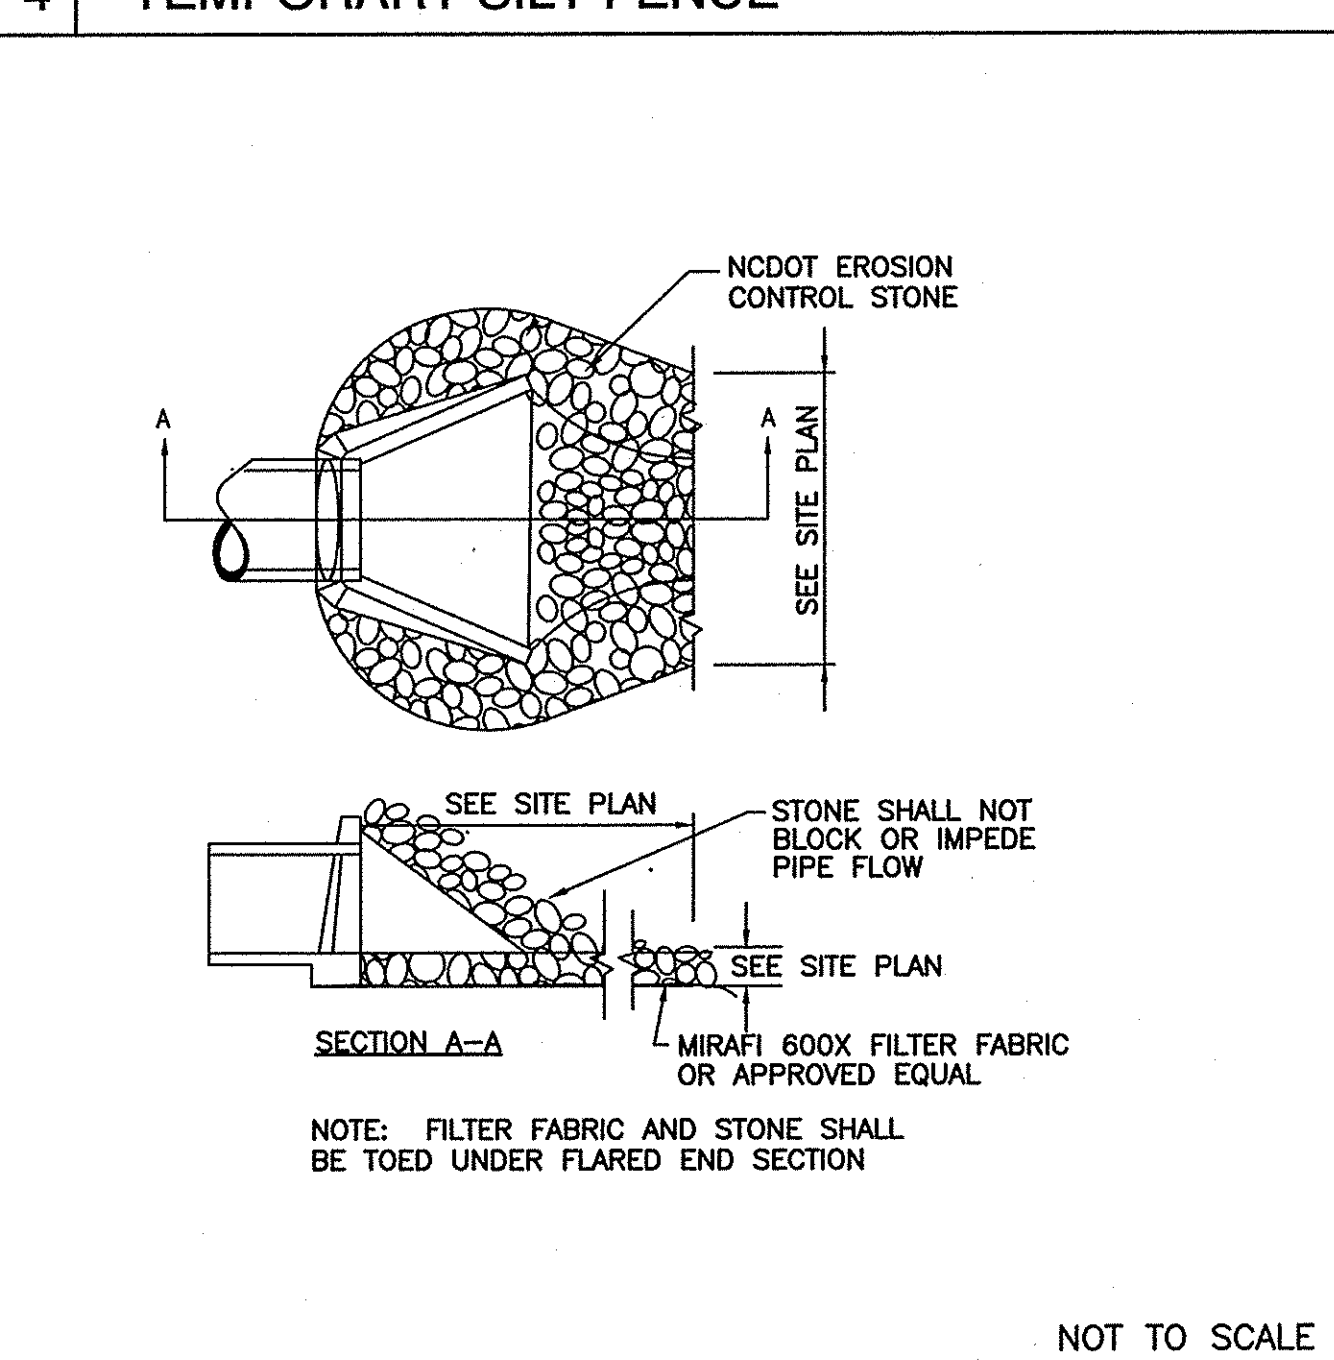

NOT TO SCALE

7 ENERGY DISSIPATOR

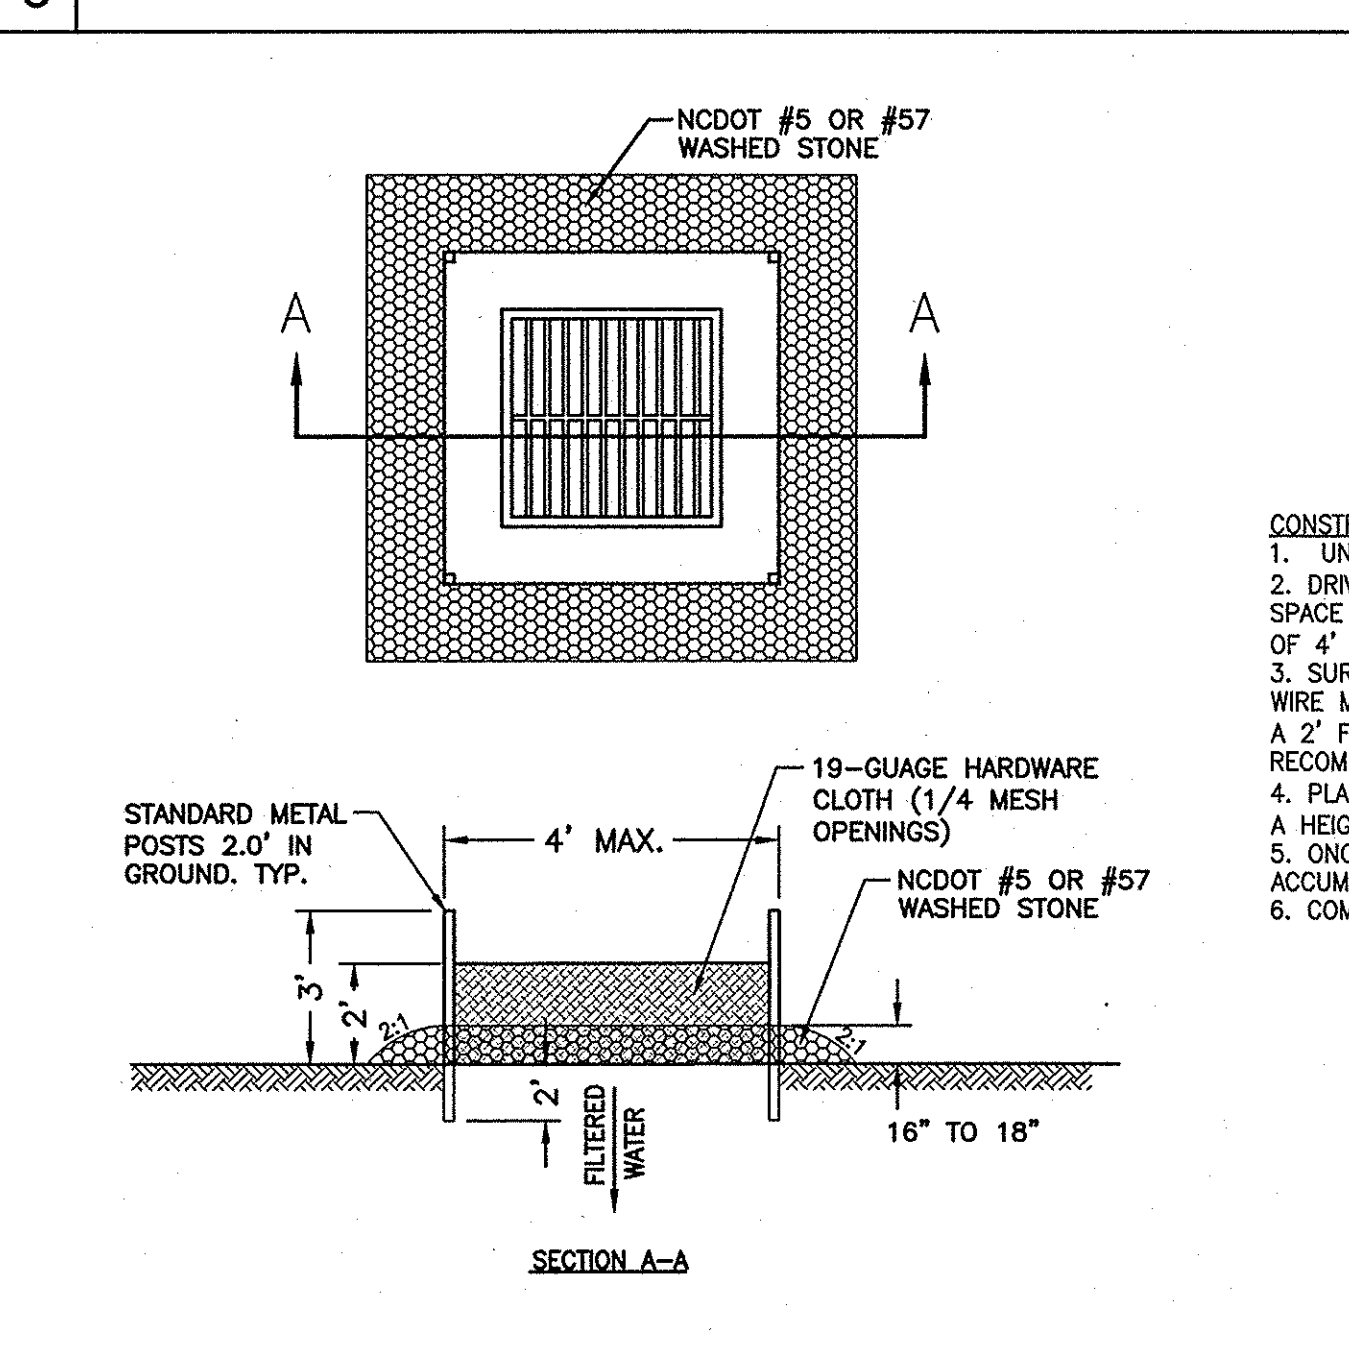


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8 HARDWARE CLOTH AND GRAVEL INLET PROTECTION

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# CAPE FEAR PUBLIC UTILITY AUTHORITY PUMP STATION 8 DESIGN

CFPUA CIP #14S283  
CFPUA MAP #131611.002  
SHIPYARD BOULEVARD  
NEW HANOVER COUNTY  
WILMINGTON, N. C.  
28 JULY 2016



**PROJECT LEGEND**

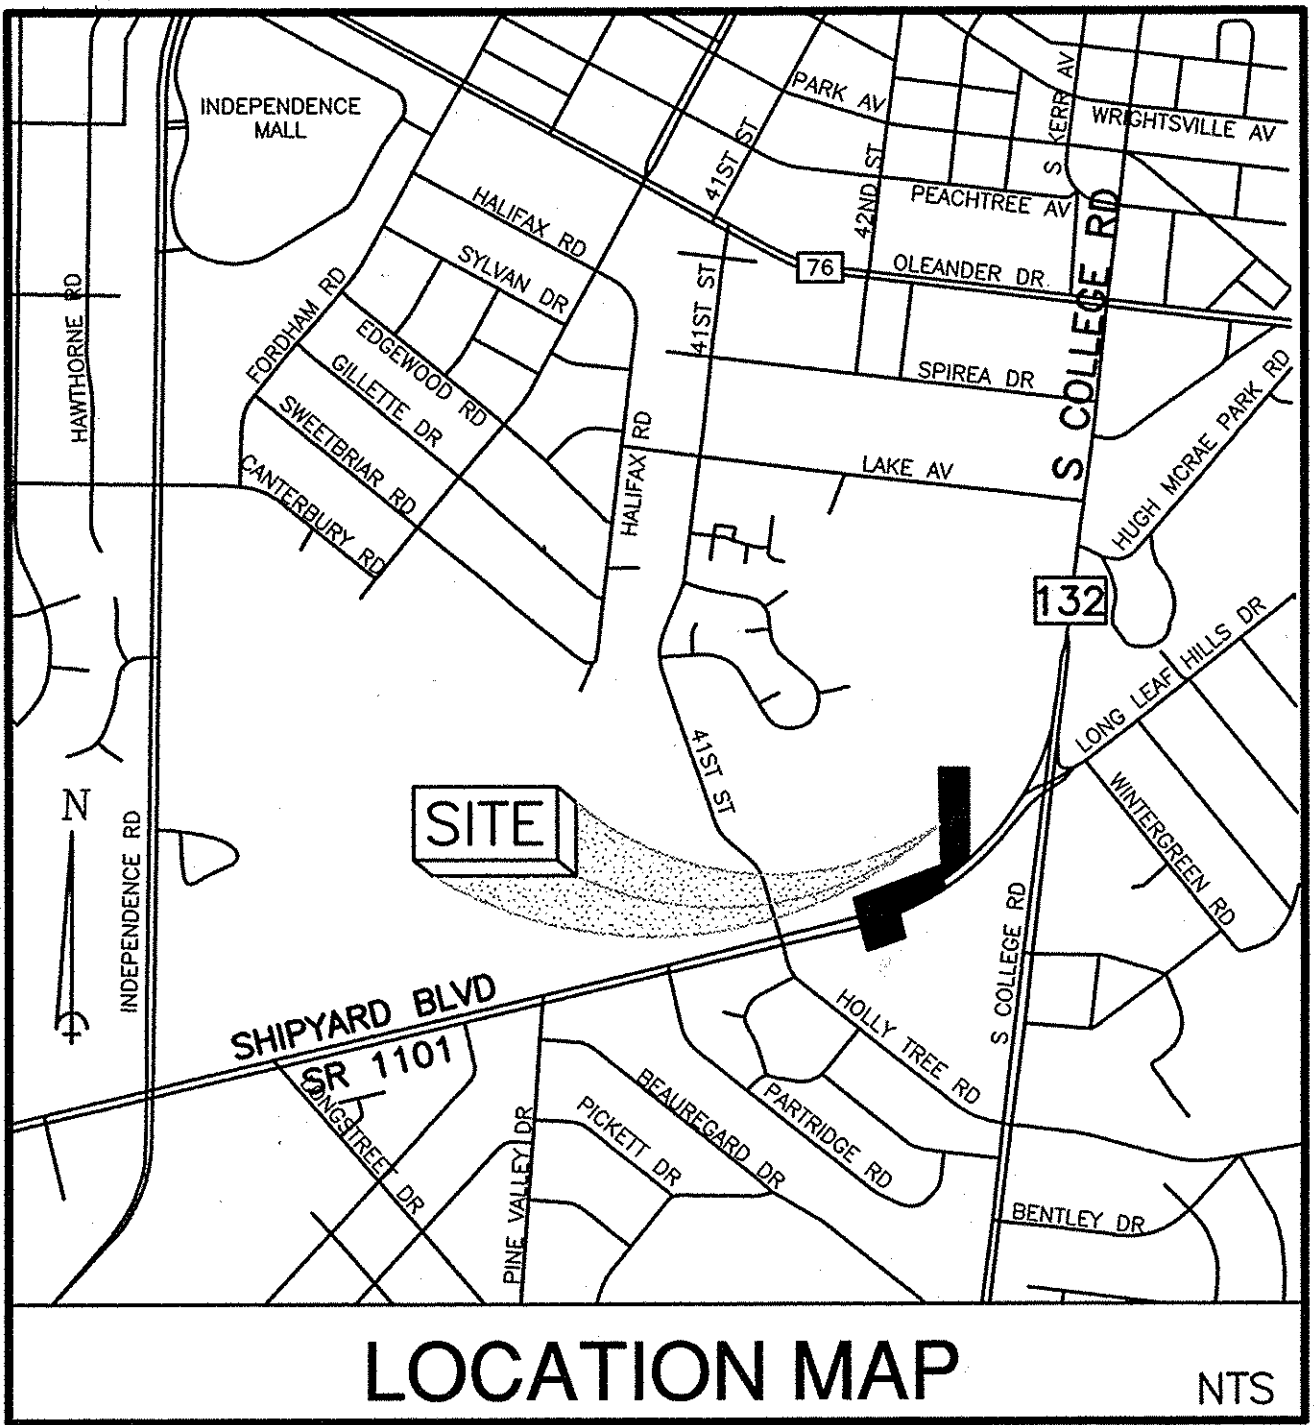	RIGHT-OF-WAY
	DISTURBED AREA LIMITS
	PROPOSED EASEMENT
	TEMPORARY SILT FENCE
	PROPOSED GRAVITY SEWER
	PROPOSED FORCEMAIN
	PROPOSED FINISH GRADE SPOT ELEVATION
	INLET PROTECTION
	EXISTING CONTOUR
	EXISTING TREE TO BE SAVED
	EXISTING TREE TO BE REMOVED

**SURVEY LEGEND**


	RIGHT OF WAY
	EDGE OF PAVEMENT LINE
	EASEMENT LINE
	FENCE
	GUARD RAIL
	OVERHEAD POWER LINE
	UNDERGROUND CABLE TV LINE
	UNDERGROUND ELECTRIC LINE
	UNDERGROUND FIBER OPTIC LINE
	UNDERGROUND GAS LINE
	UNDERGROUND TELEPHONE
	UNDERGROUND TRAFFIC SIGNAL
	UNDERGROUND WATER LINE
	STORM SEWER PIPE
	SANITARY SEWER PIPE
	FORCE MAIN PIPE
	UNDERGROUND TRAFFIC LINE

**INDEX OF SHEETS**

<b>COVER SHEET</b>	
C1:	EROSION CONTROL AND TREE REMOVAL PLAN
C2:	EROSION CONTROL AND TREE REMOVAL PLAN
C3:	NOTES AND DETAILS
PR1:	SSFM PLAN AND PROFILE
PR2:	SSFM PLAN AND PROFILE
PR3:	GRAVITY SEWER PLAN AND PROFILE
PR4:	LIFT STATION SITE PLAN
PR5:	LIFT STATION DETAILS
SSD-1:	SANITARY SEWER STANDARD DETAILS
SSD-2:	SANITARY SEWER STANDARD DETAILS
SSD-3:	SANITARY SEWER STANDARD DETAILS
<b>SUPPLEMENTAL SHEETS:</b>	
(1)	EXISTING LIFT STATION #8 AS BUILT DETAILS
(2)	EXISTING LIFT STATION #8 AS BUILT PROFILES

**SEWER QUANTITIES FOR PROJECT**

GRAVITY SANITARY SEWER:	130 LF 12"
SANITARY SEWER FORCEMAIN:	1,135 LF 10"

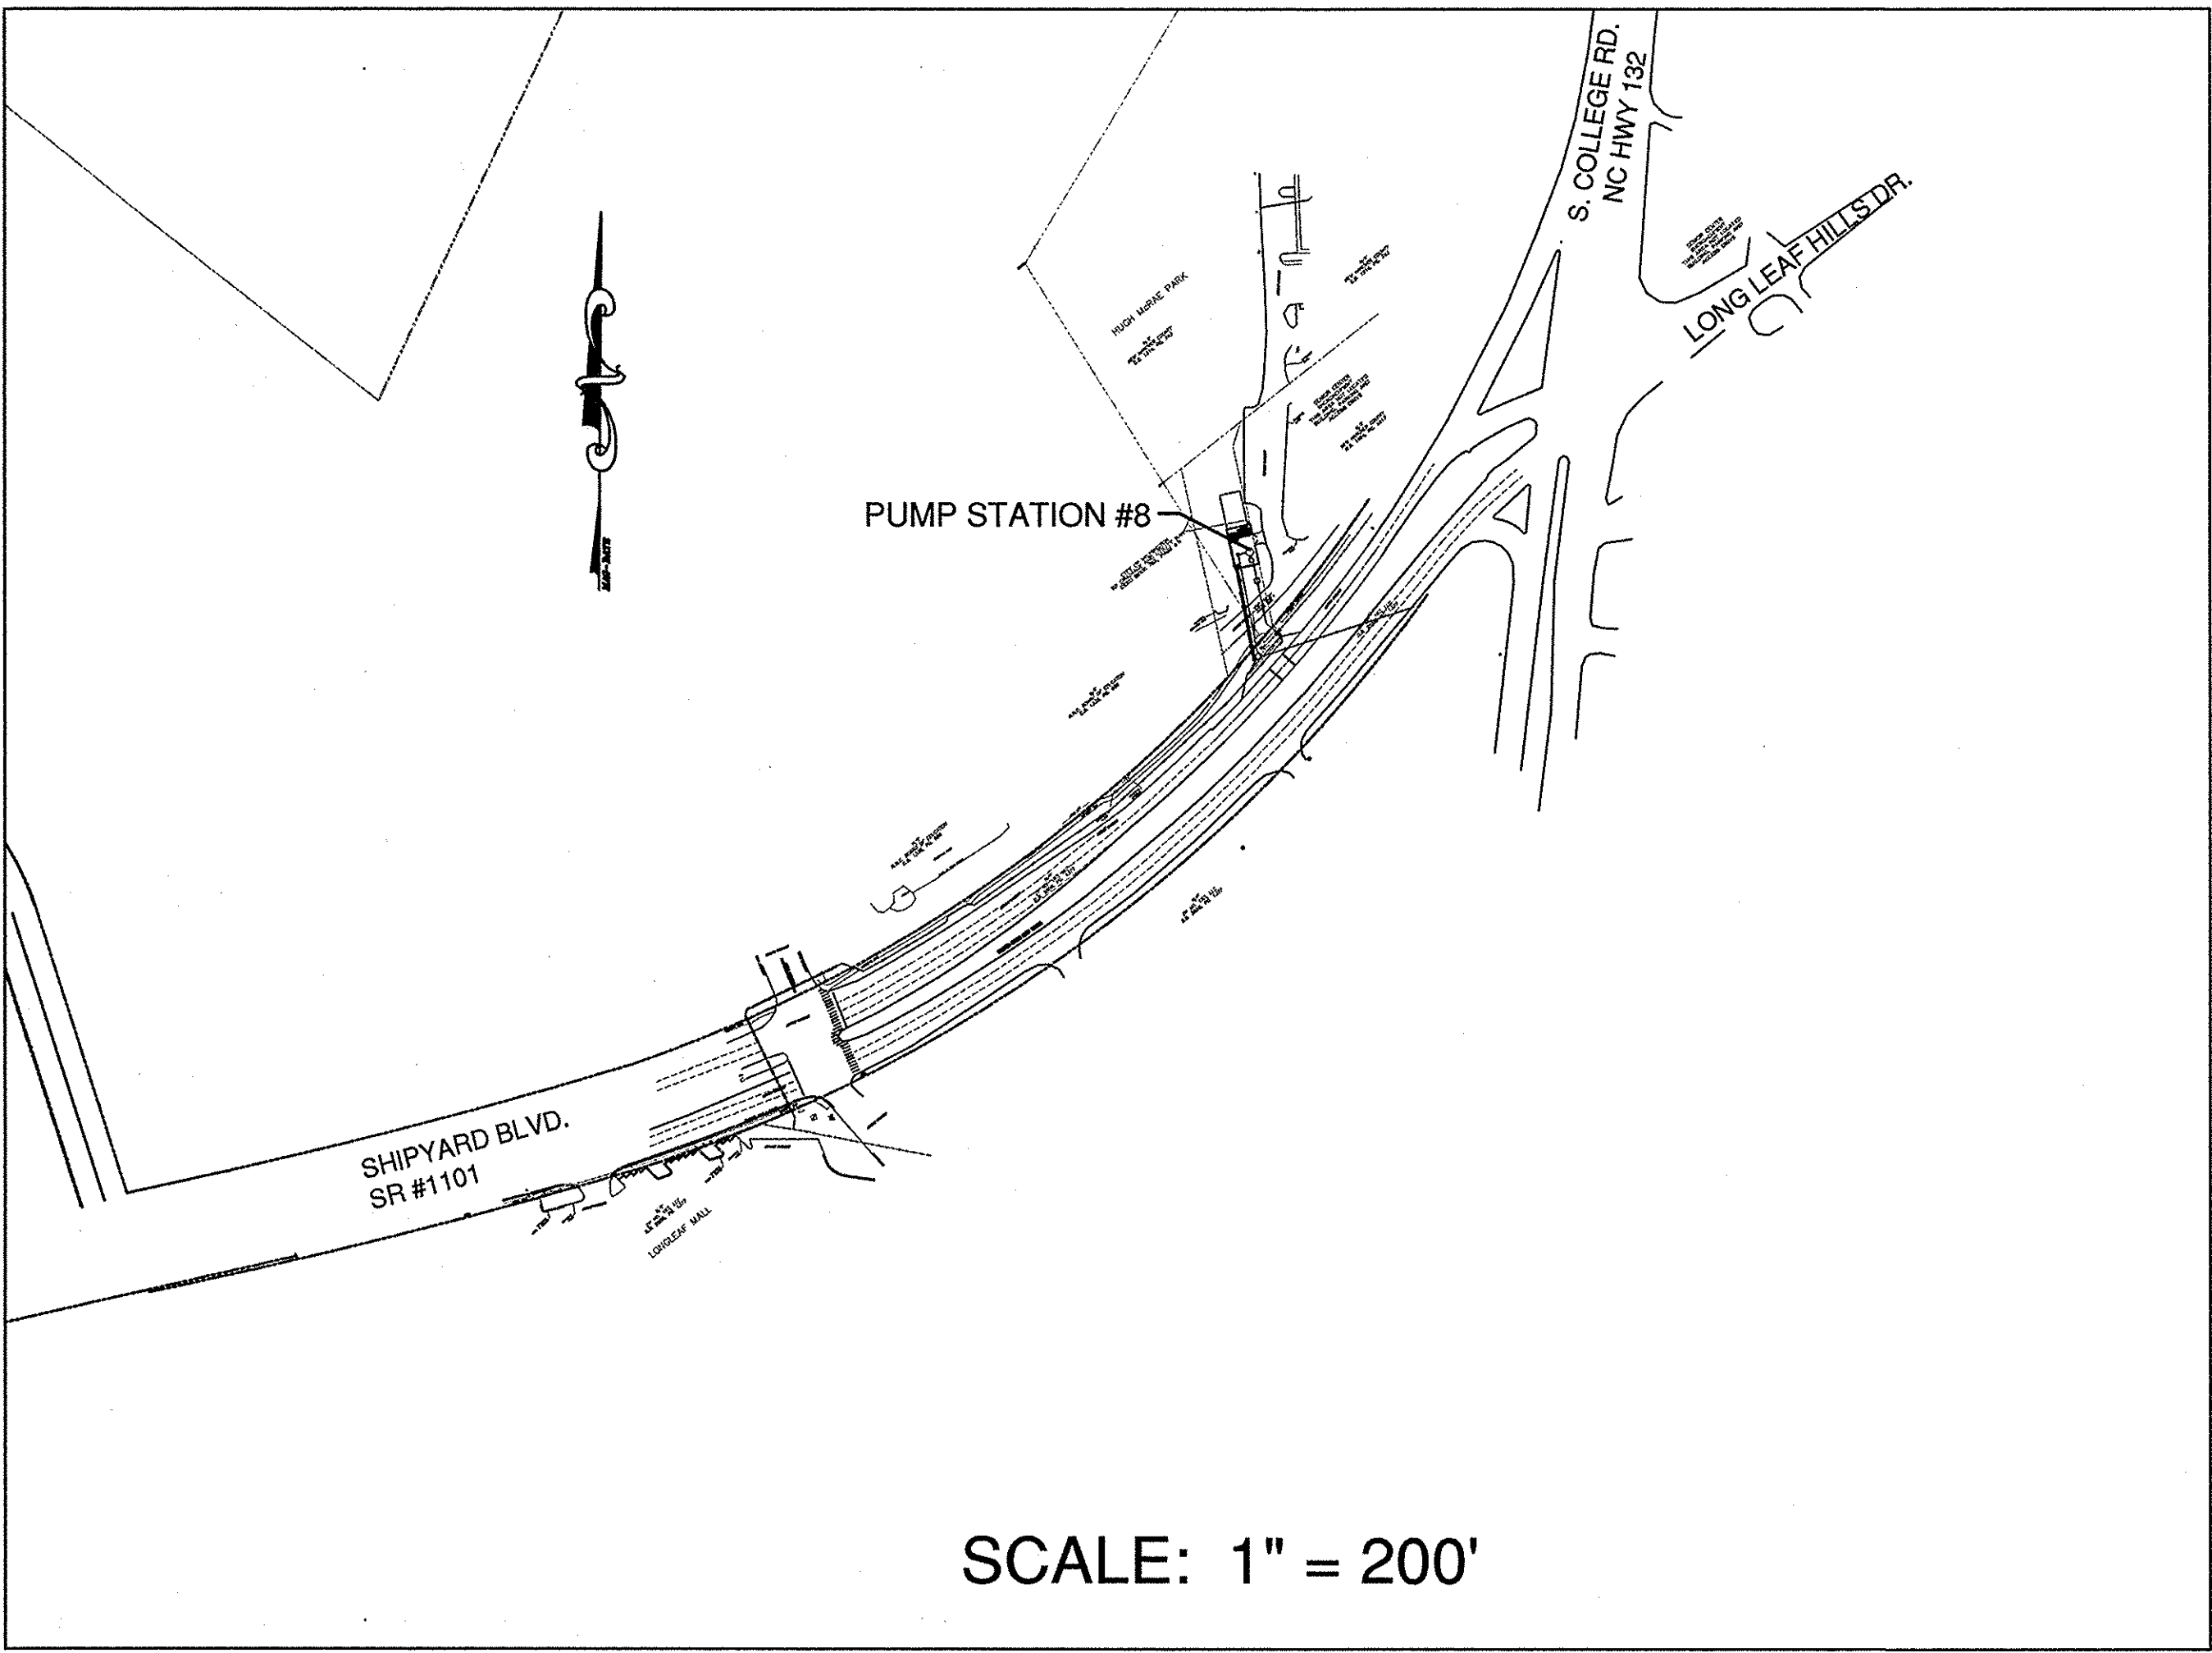

**DESIGN TEAM:**

**LEAD DESIGN ENGINEER**  
**NORRIS & TUNSTALL**

**CONSULTING ENGINEERS, P.C.**

902 MARKET STREET WILMINGTON, NC 28401  
PHONE (910) 343-9653  
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office@nkteng.com  
licence #C-3641

**OWNER**




CFPUA  
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235 GOVERNMENT CENTER DR.  
WILMINGTON, NC 28403  
910 332-6673

**ELECTRICAL**

CHEATHAM & ASSOCIATES, PA  
CONSULTING ENGINEERS  
3412 ENTERPRISE DRIVE  
WILMINGTON, NC 28405  
910 452-4210



**SURVEYOR**

ROBERT H. GOSLEE & ASSOCIATES, PA  
LAND SURVEYORS - LAND PLANNERS  
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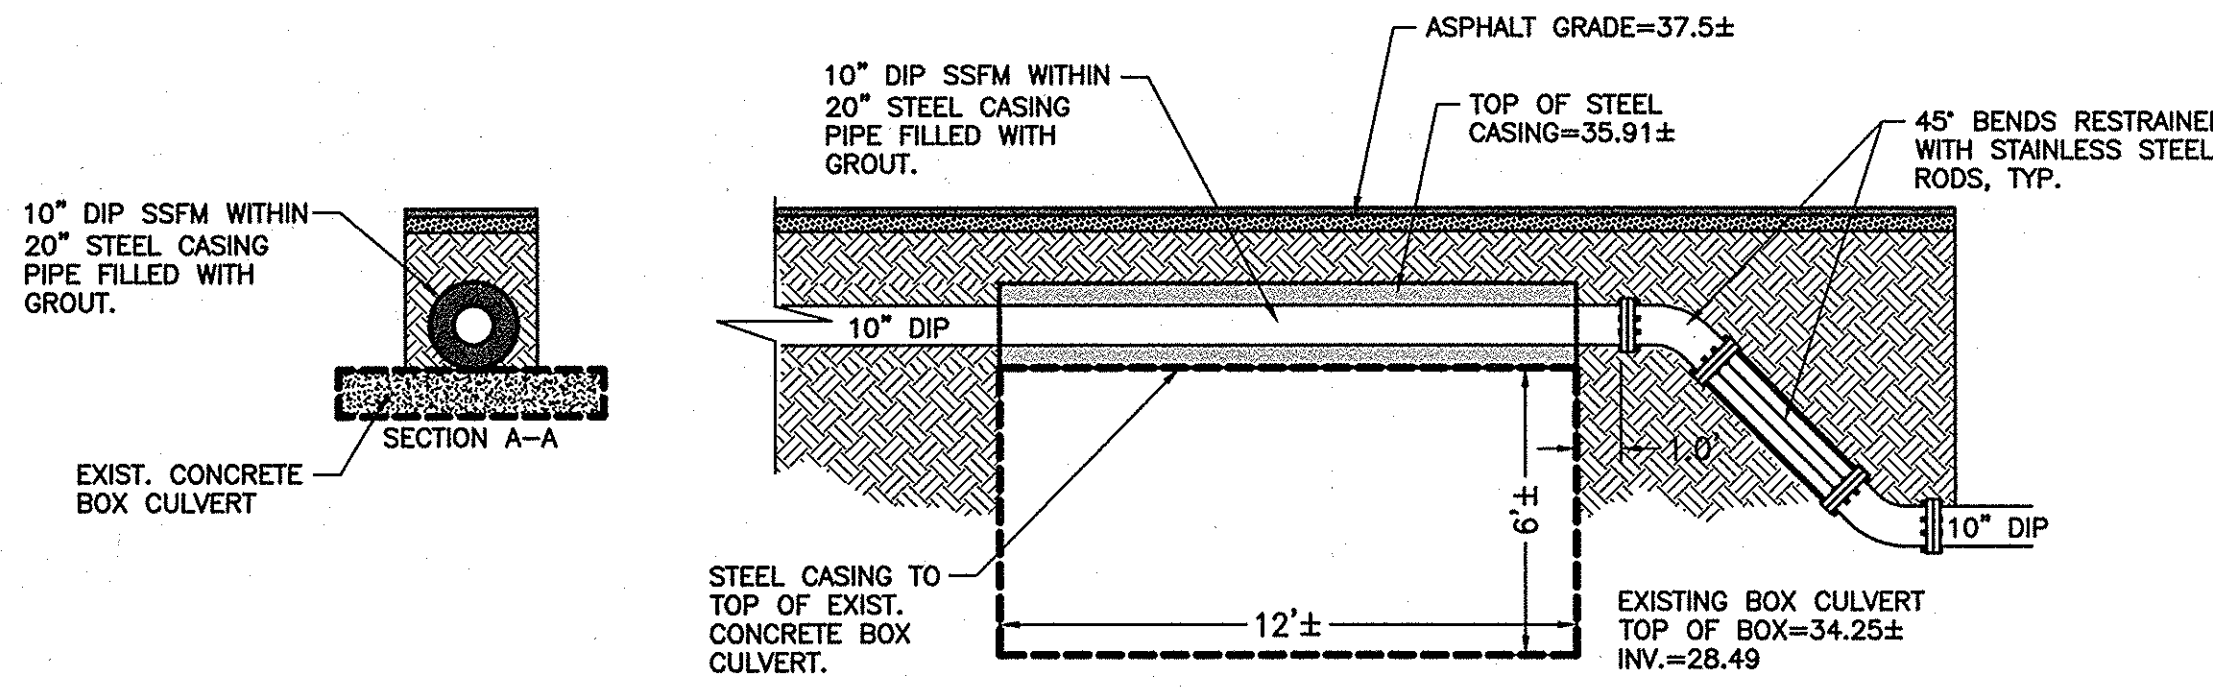


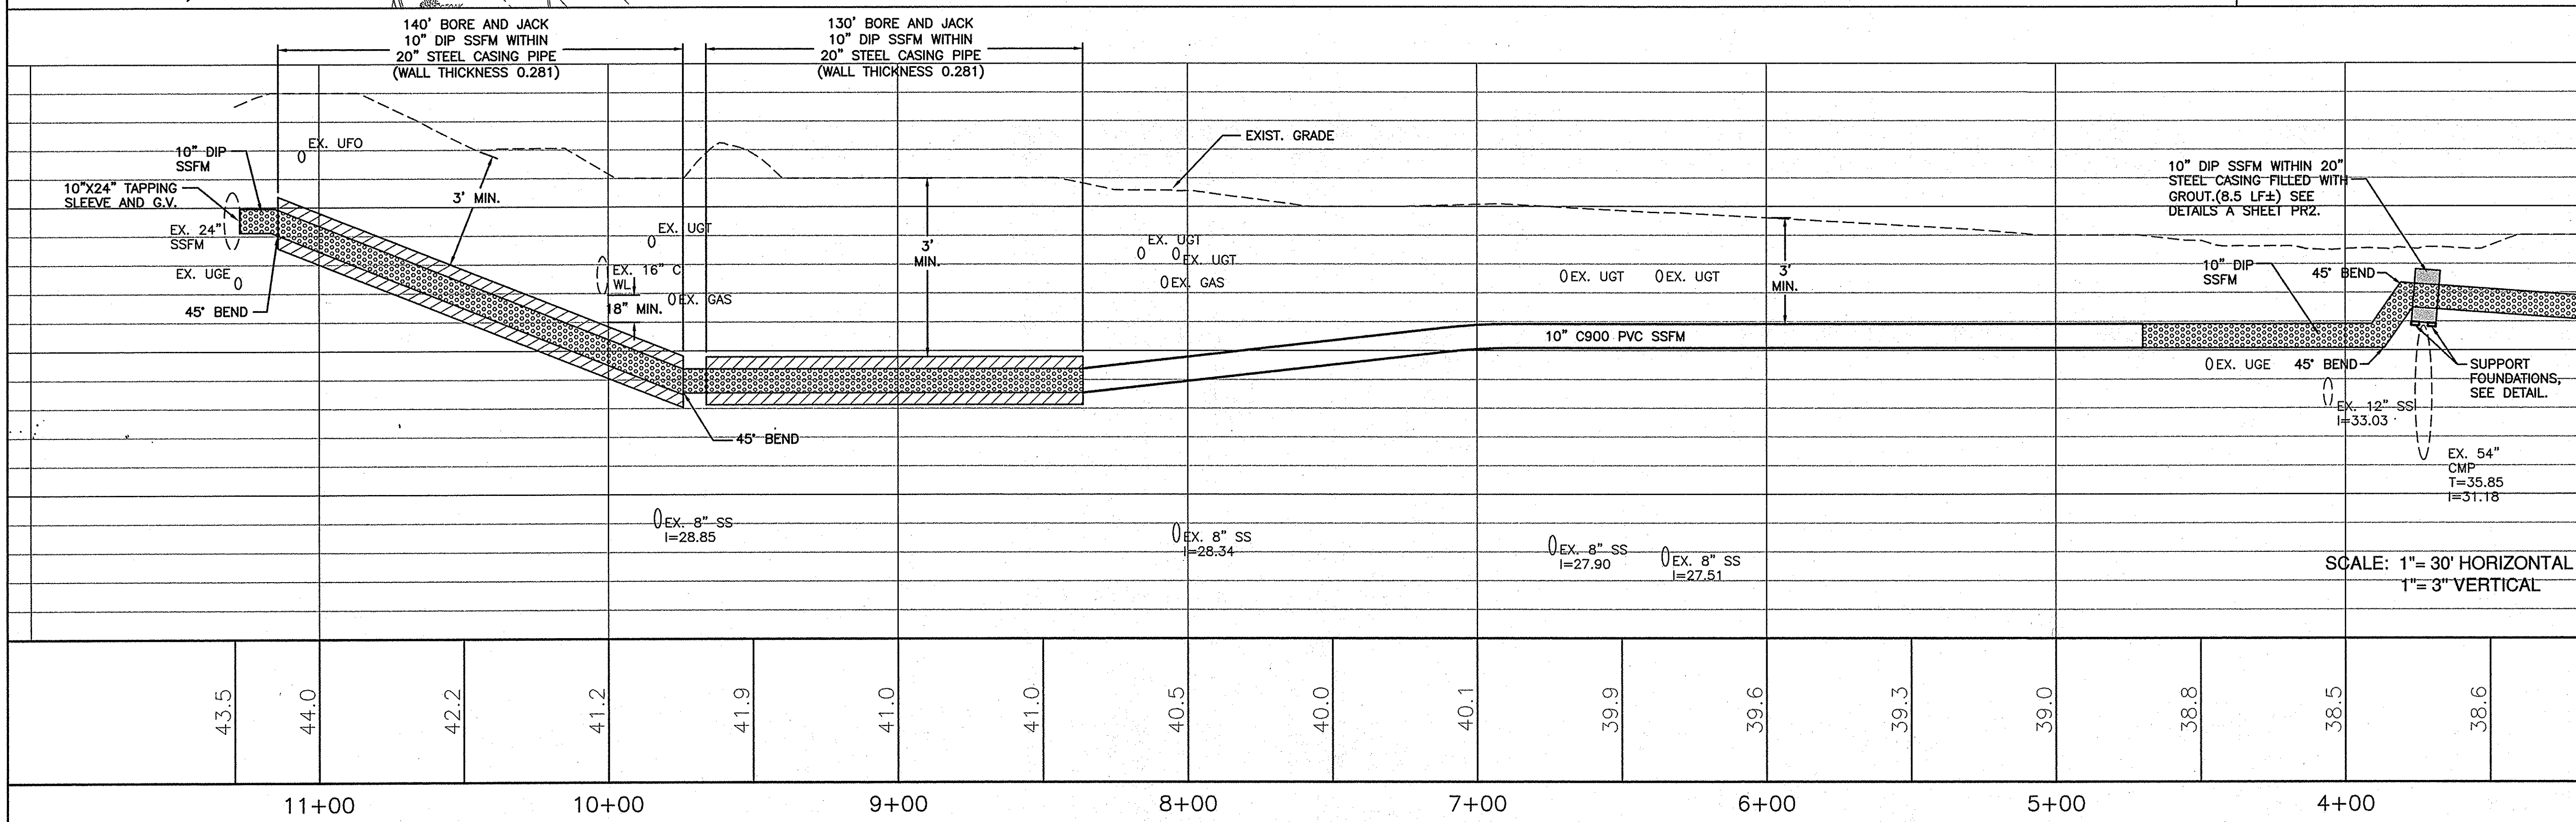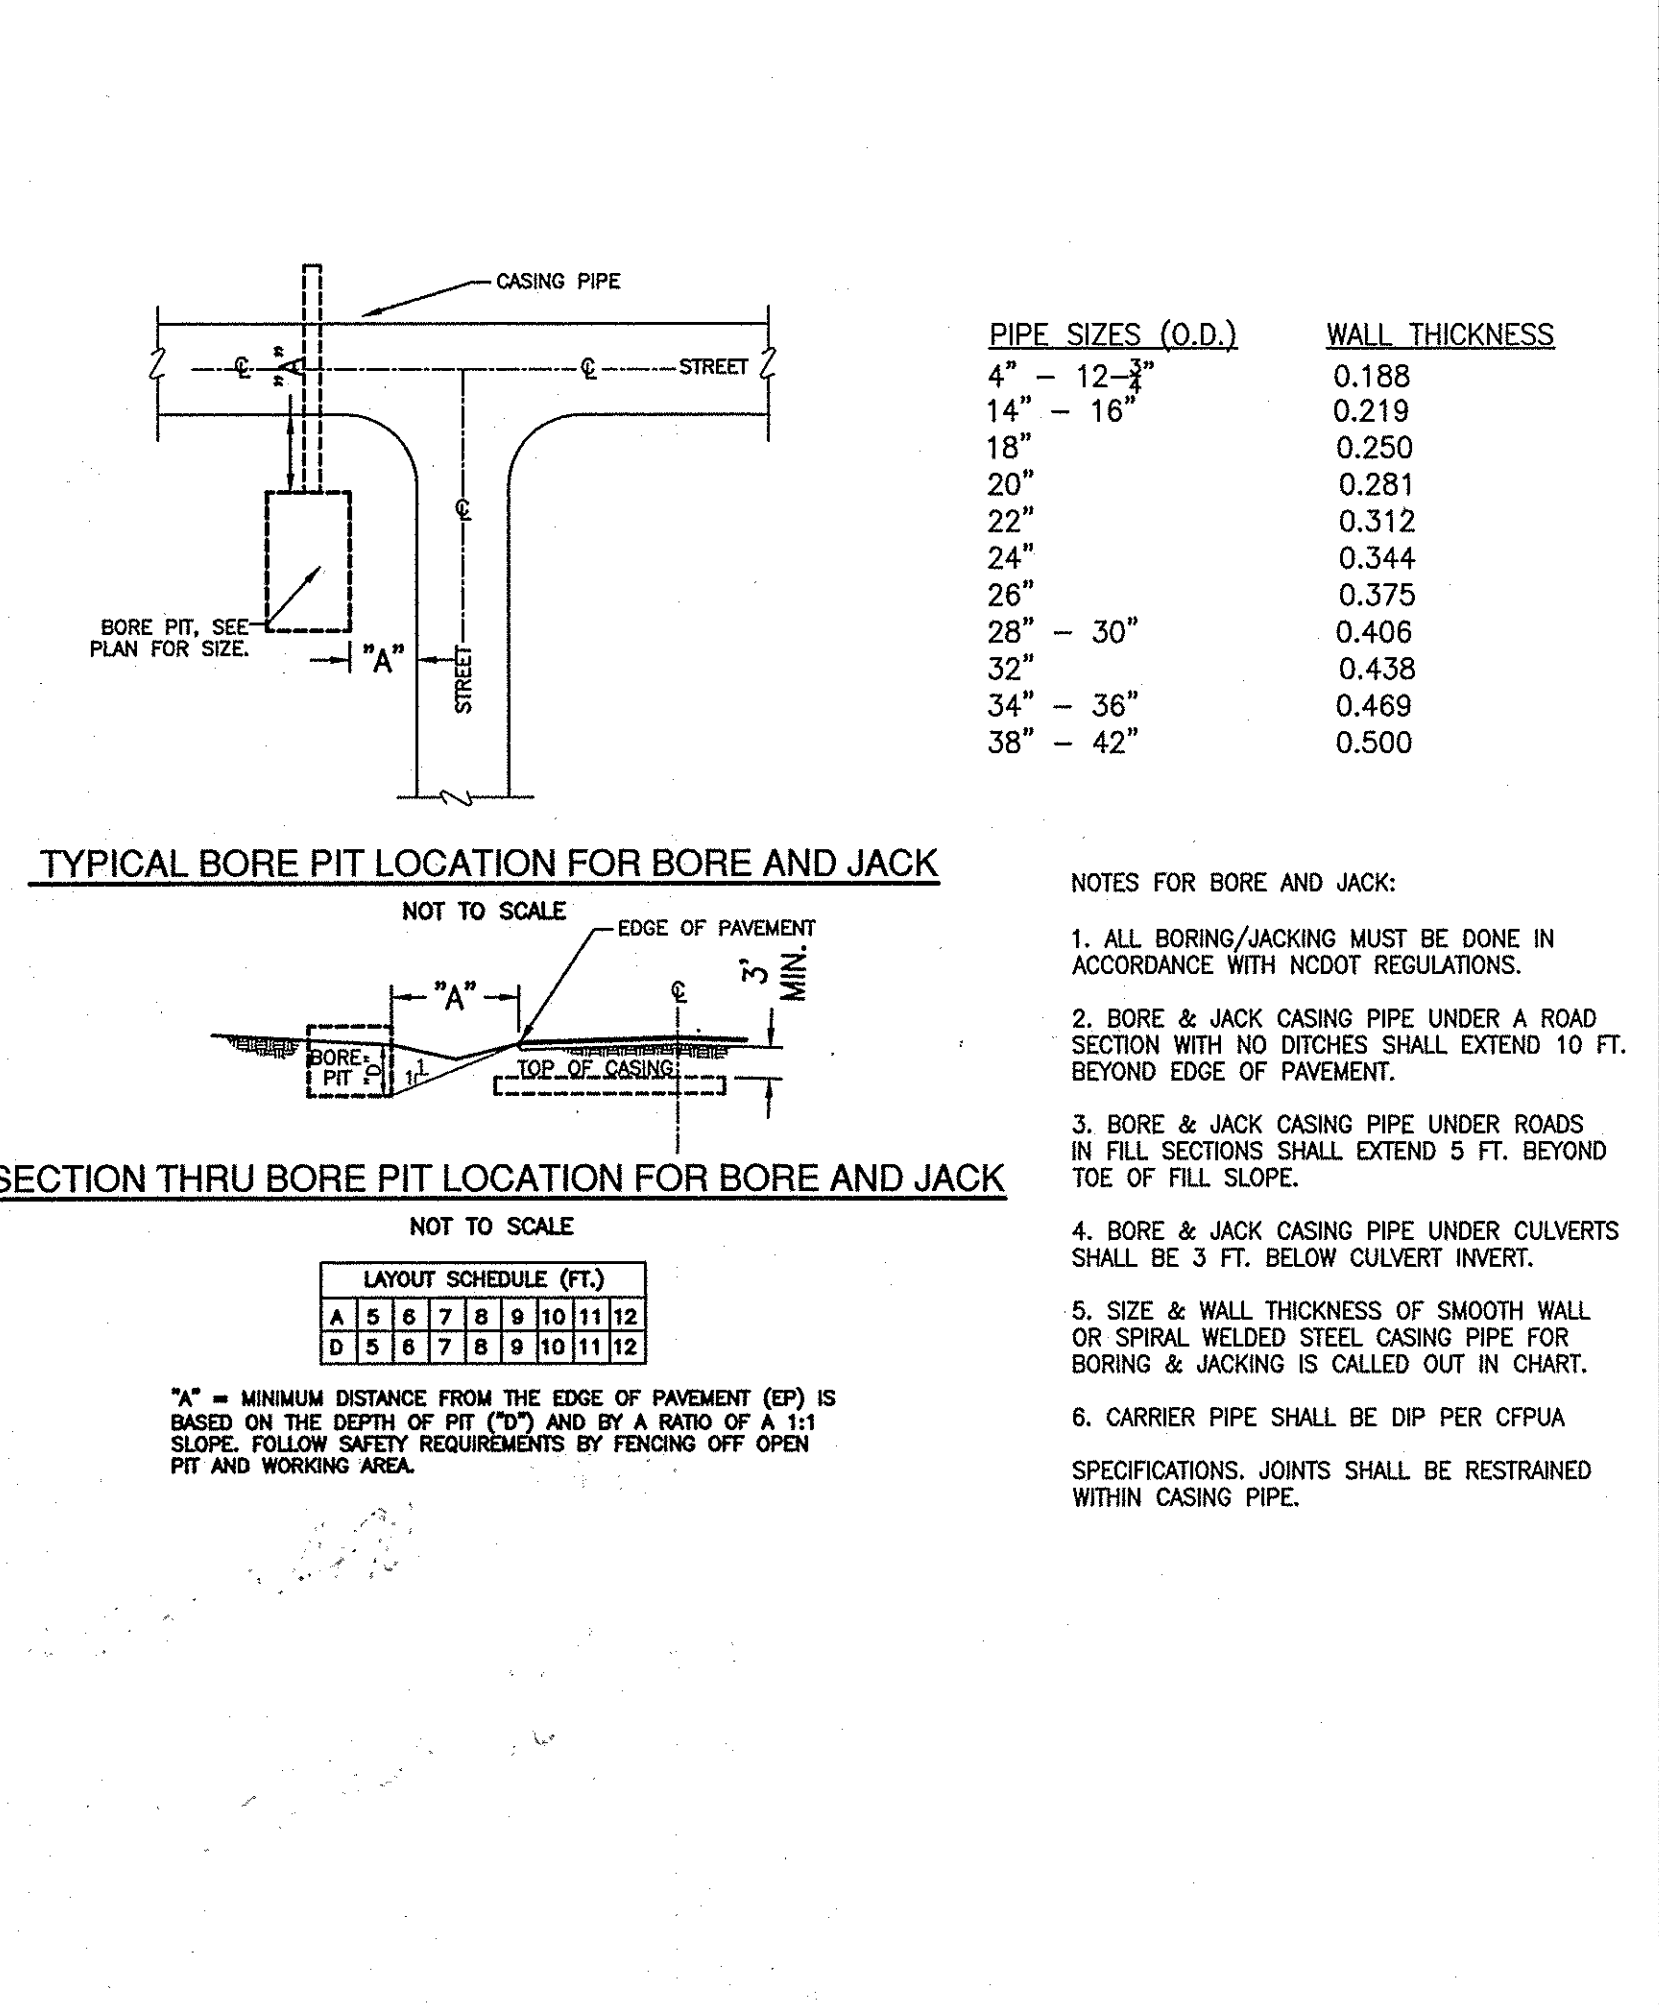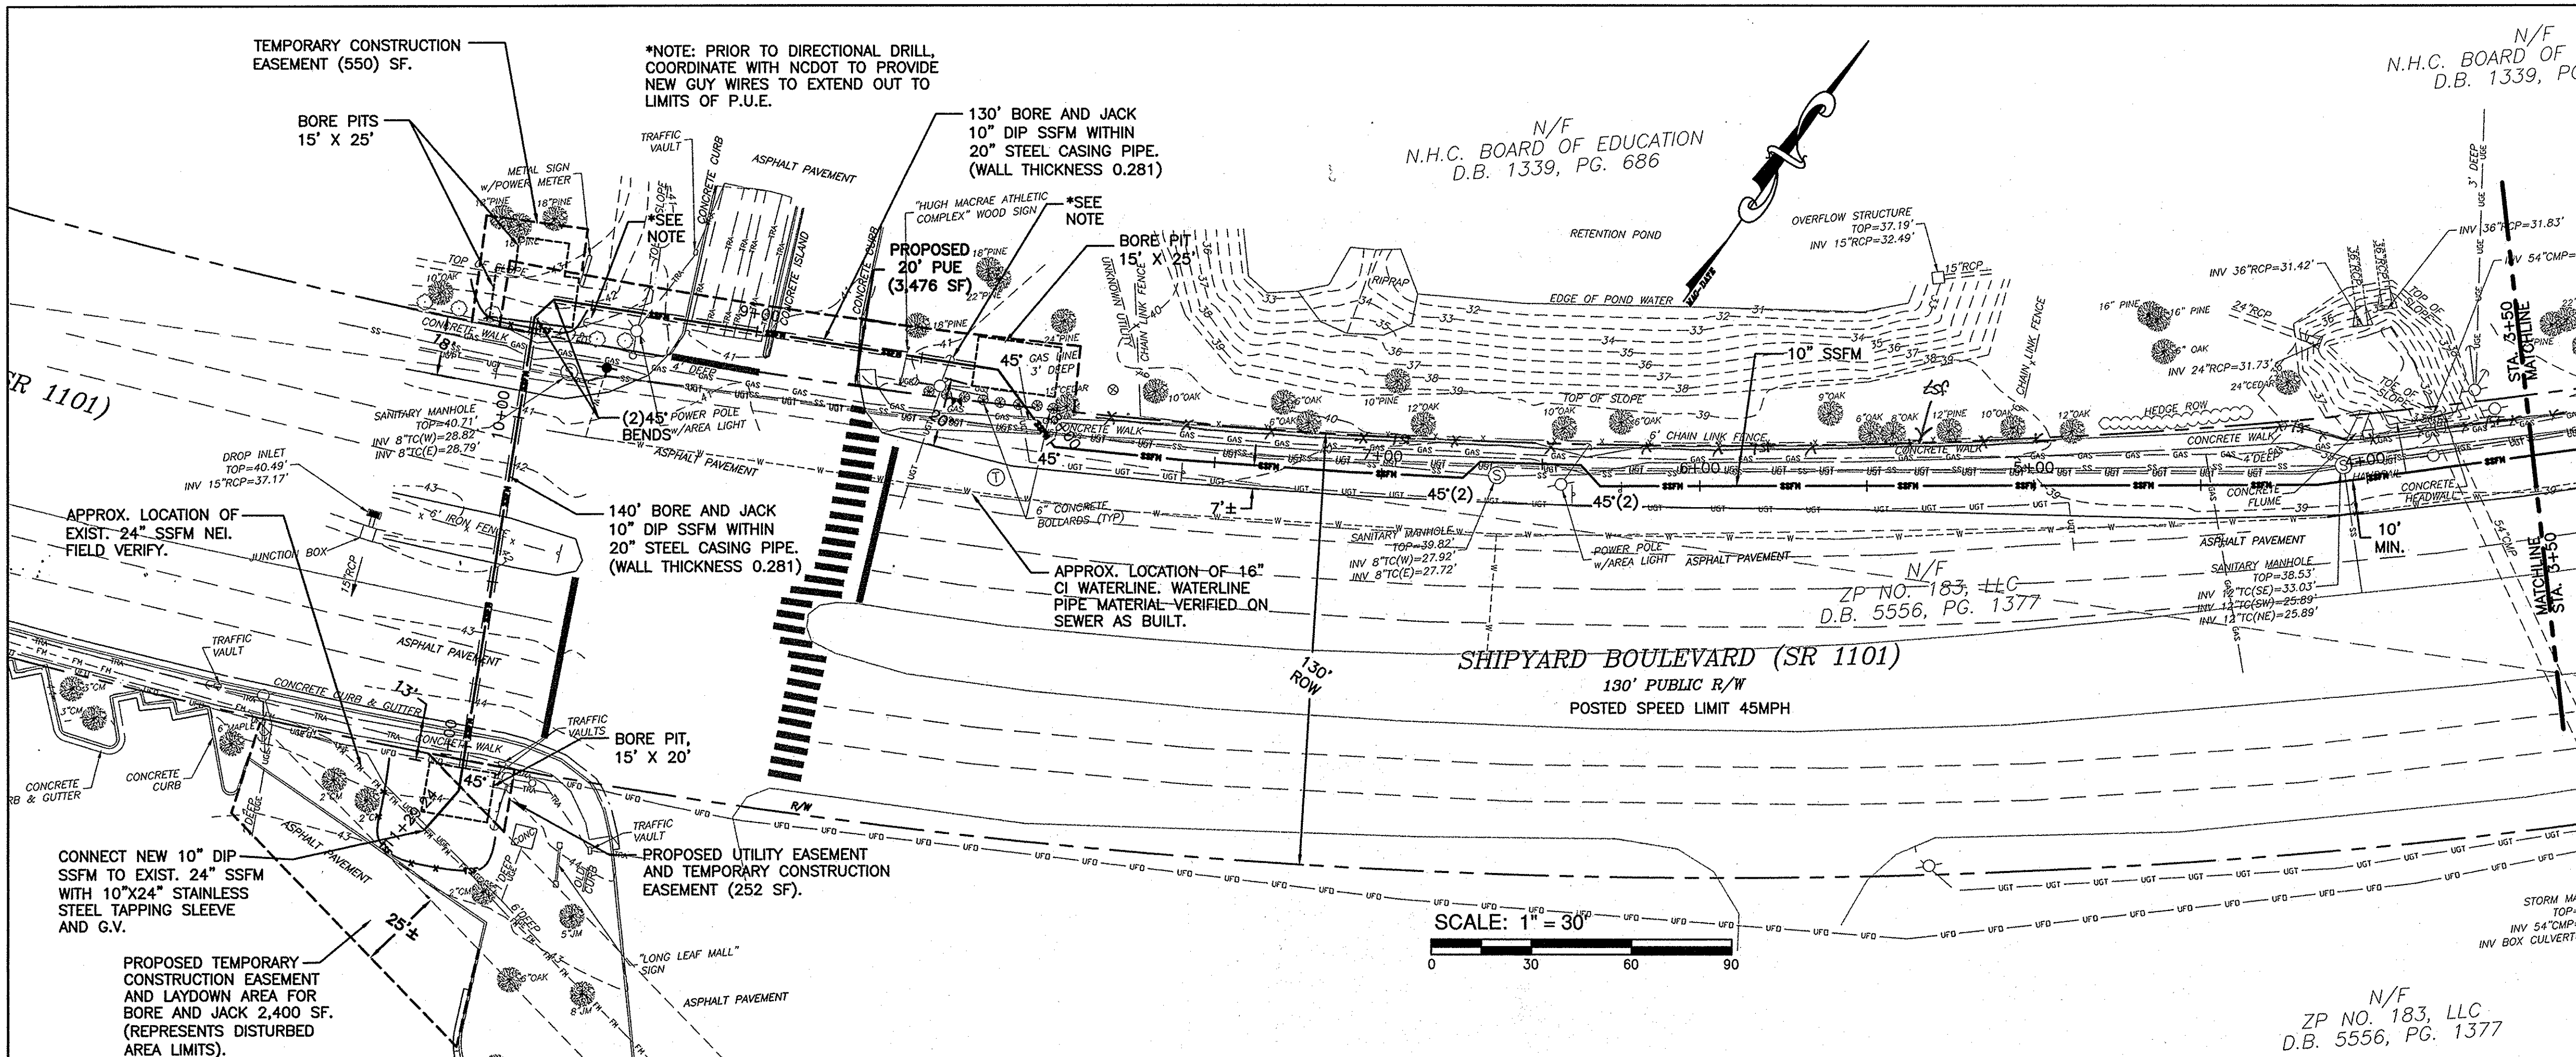		<b>NORRIS &amp; TUNSTALL</b> CONSULTING ENGINEERS, INC. 902 MARKET STREET WILMINGTON, NC 28401 PHONE (910) 343-9853 FAX (910) 343-9804 since 1952	DATE: 6/28/16	SHEET NO: <b>PR1</b>
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<b>PLAN AND PROFILE PUMP STATION 8 DESIGN SHIPYARD BOULEVARD NEW HANOVER COUNTY</b>			CHECKED: JST	PROJECT NO: 15048


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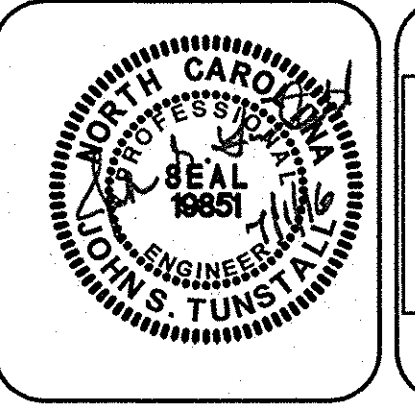
**DETAIL A**  
10" FORCEMAIN CROSSING 54" CMP  
(NOT TO SCALE)

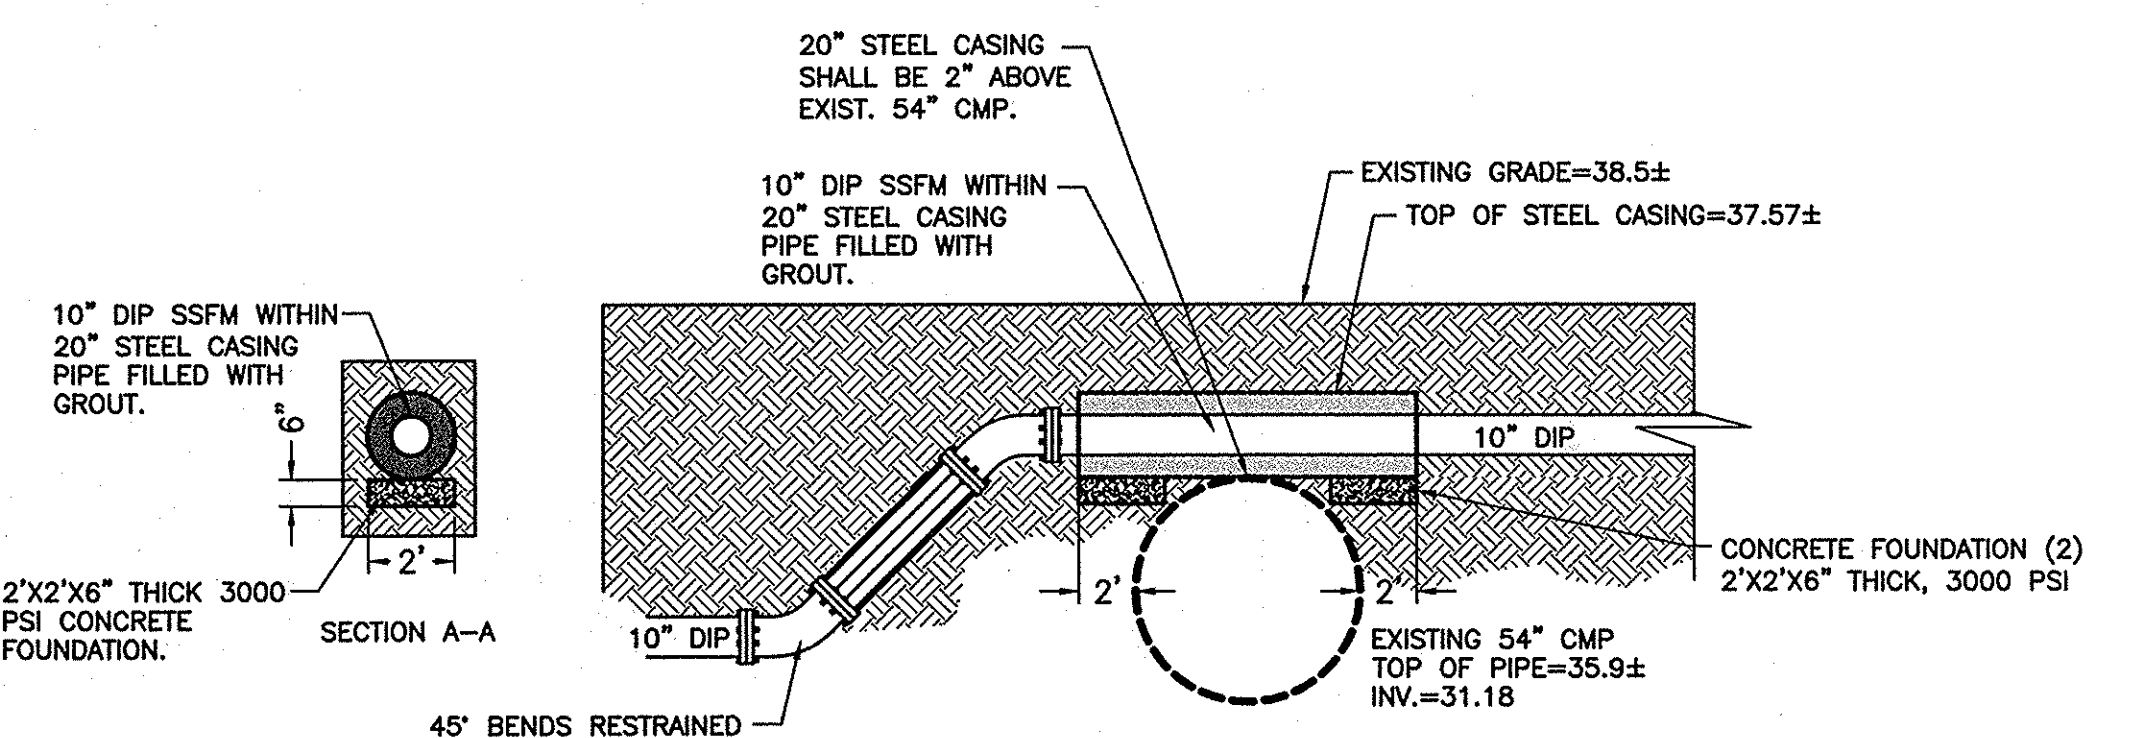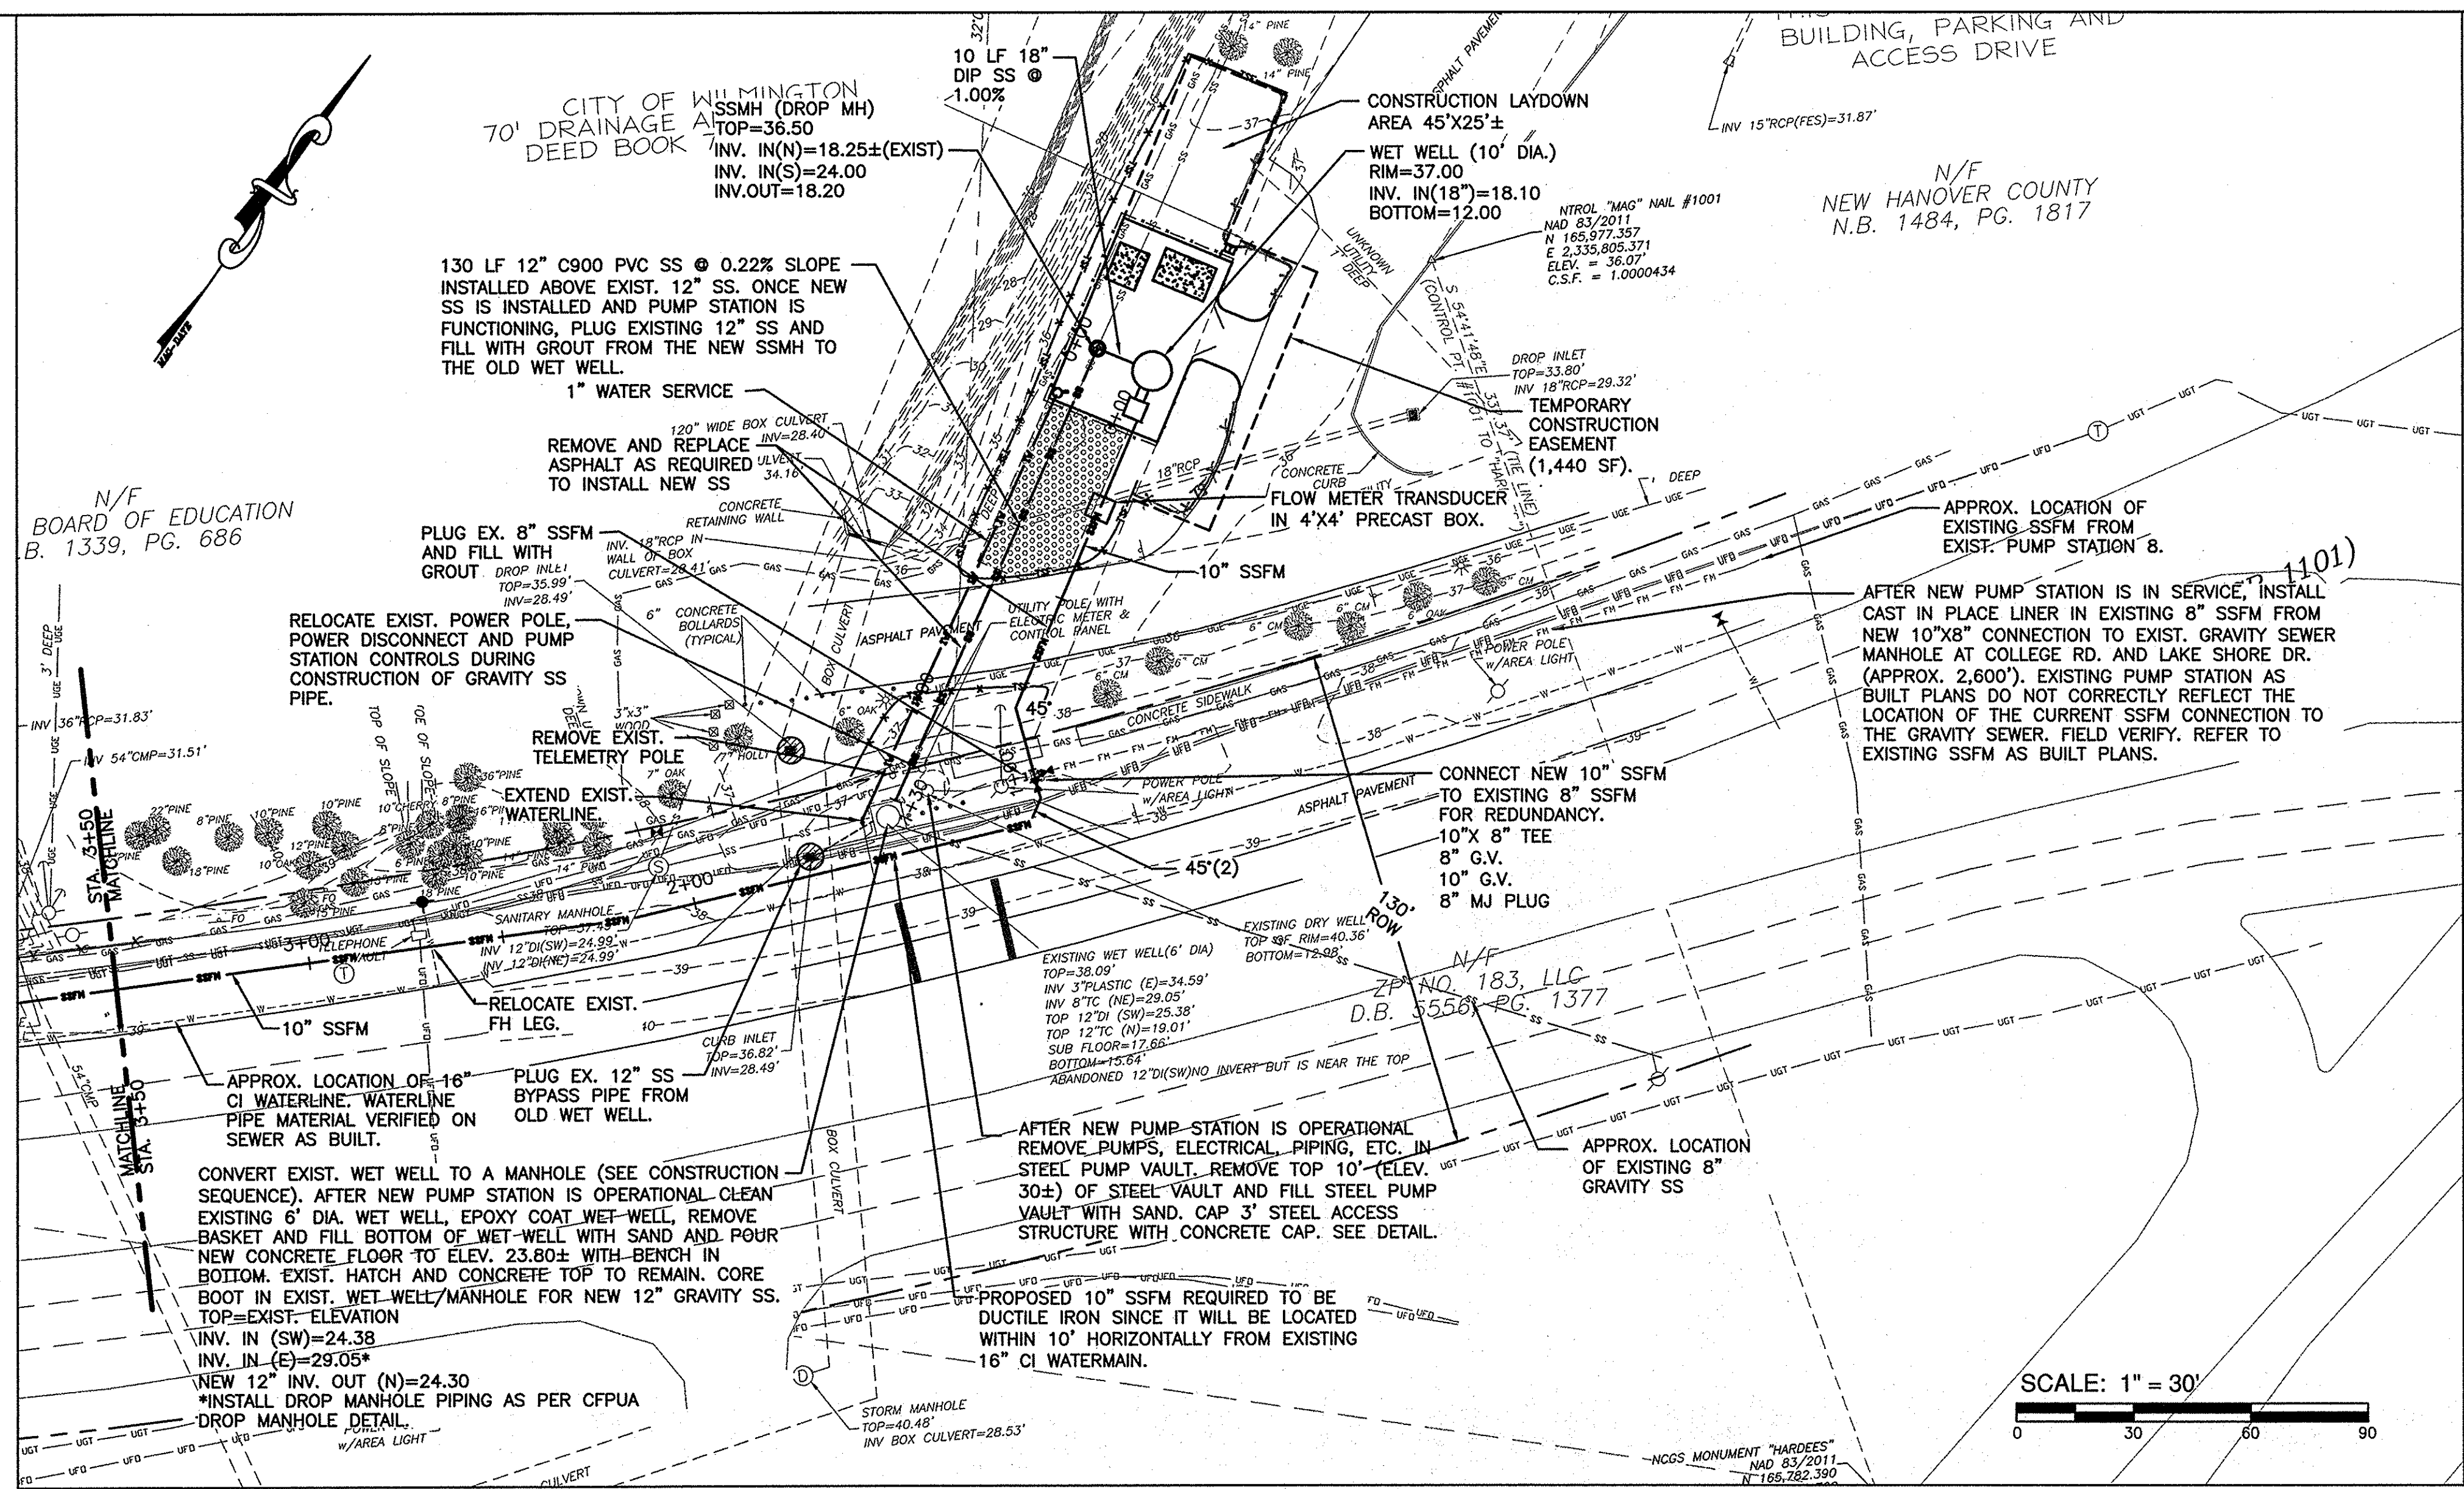

**DETAIL B**  
10" FORCEMAIN CROSSING BOX CULVERT  
(NOT TO SCALE)



REV NO.	DESCRIPTION	DATE

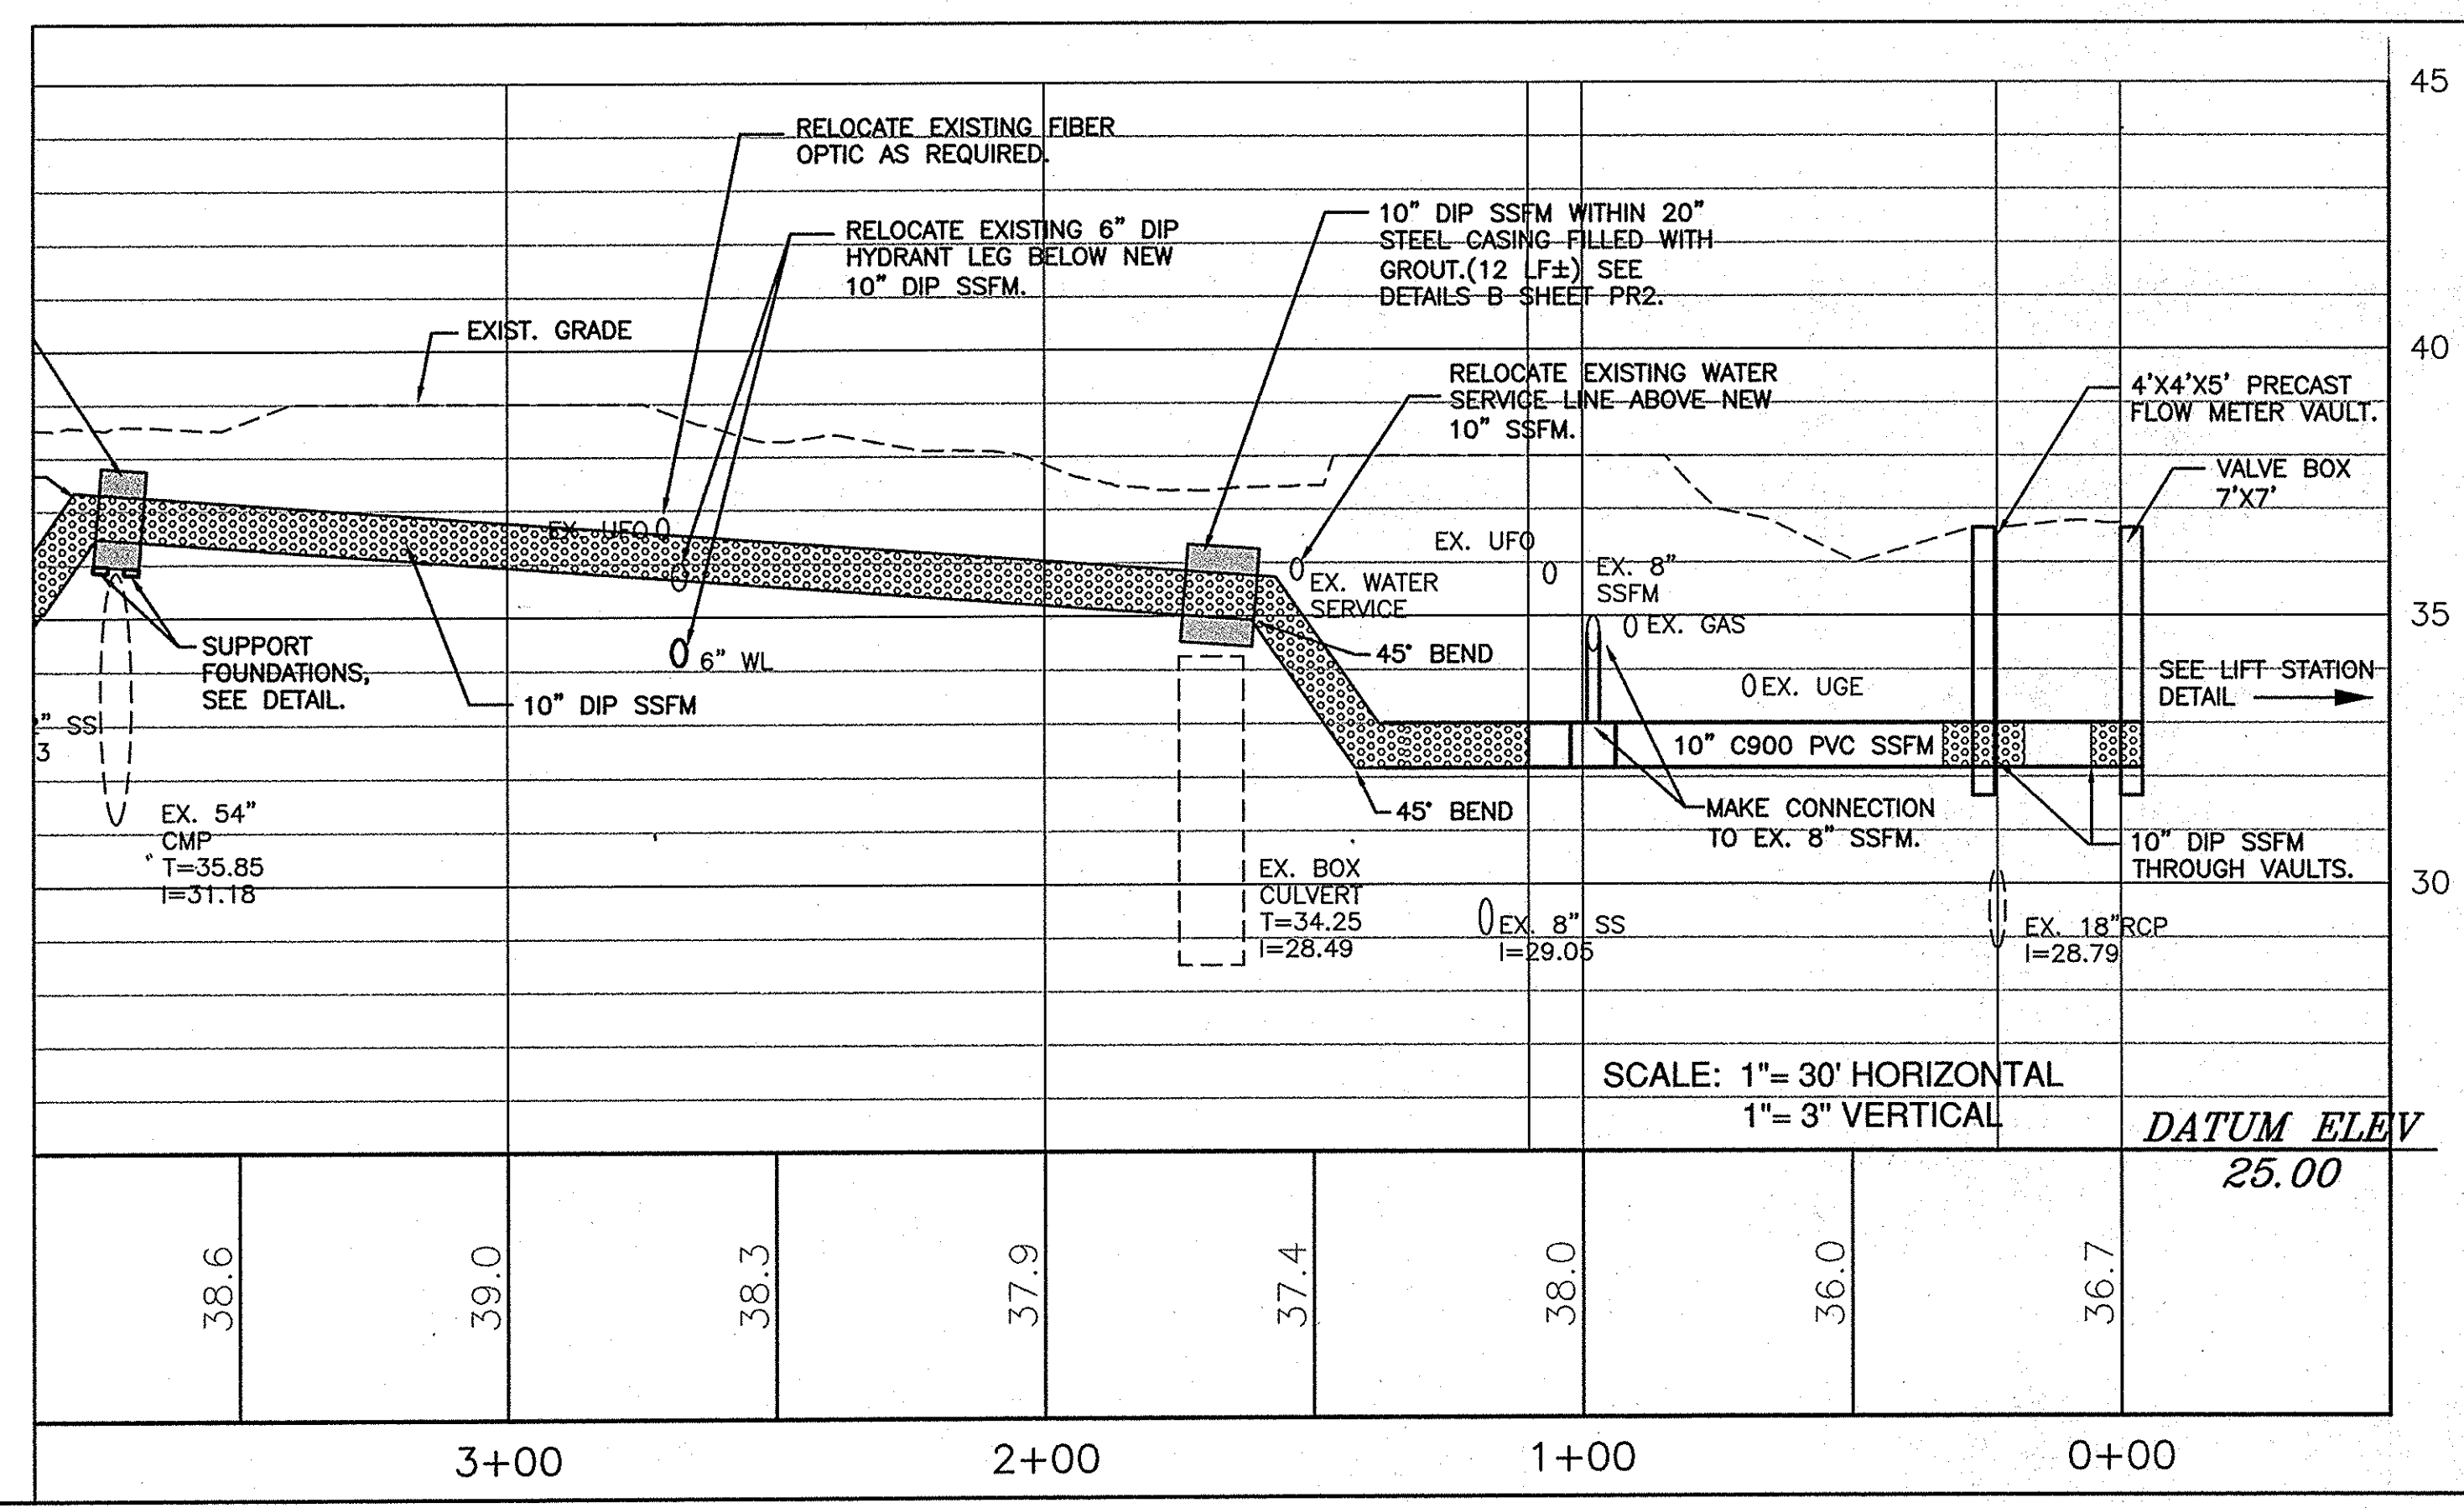



**NORRIS & TUNSTALL**  
CONSULTING ENGINEERS, INC.  
902 MARKET STREET WILMINGTON, NC 28401  
PHONE (910) 343-9653 FAX (910) 343-9804  
LICENSE #C-0520

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PROJECT NO: 15048


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**PR2**

PLAN AND PROFILE  
PUMP STATION 8 DESIGN  
SHIPYARD BOULEVARD  
NEW HANOVER COUNTY

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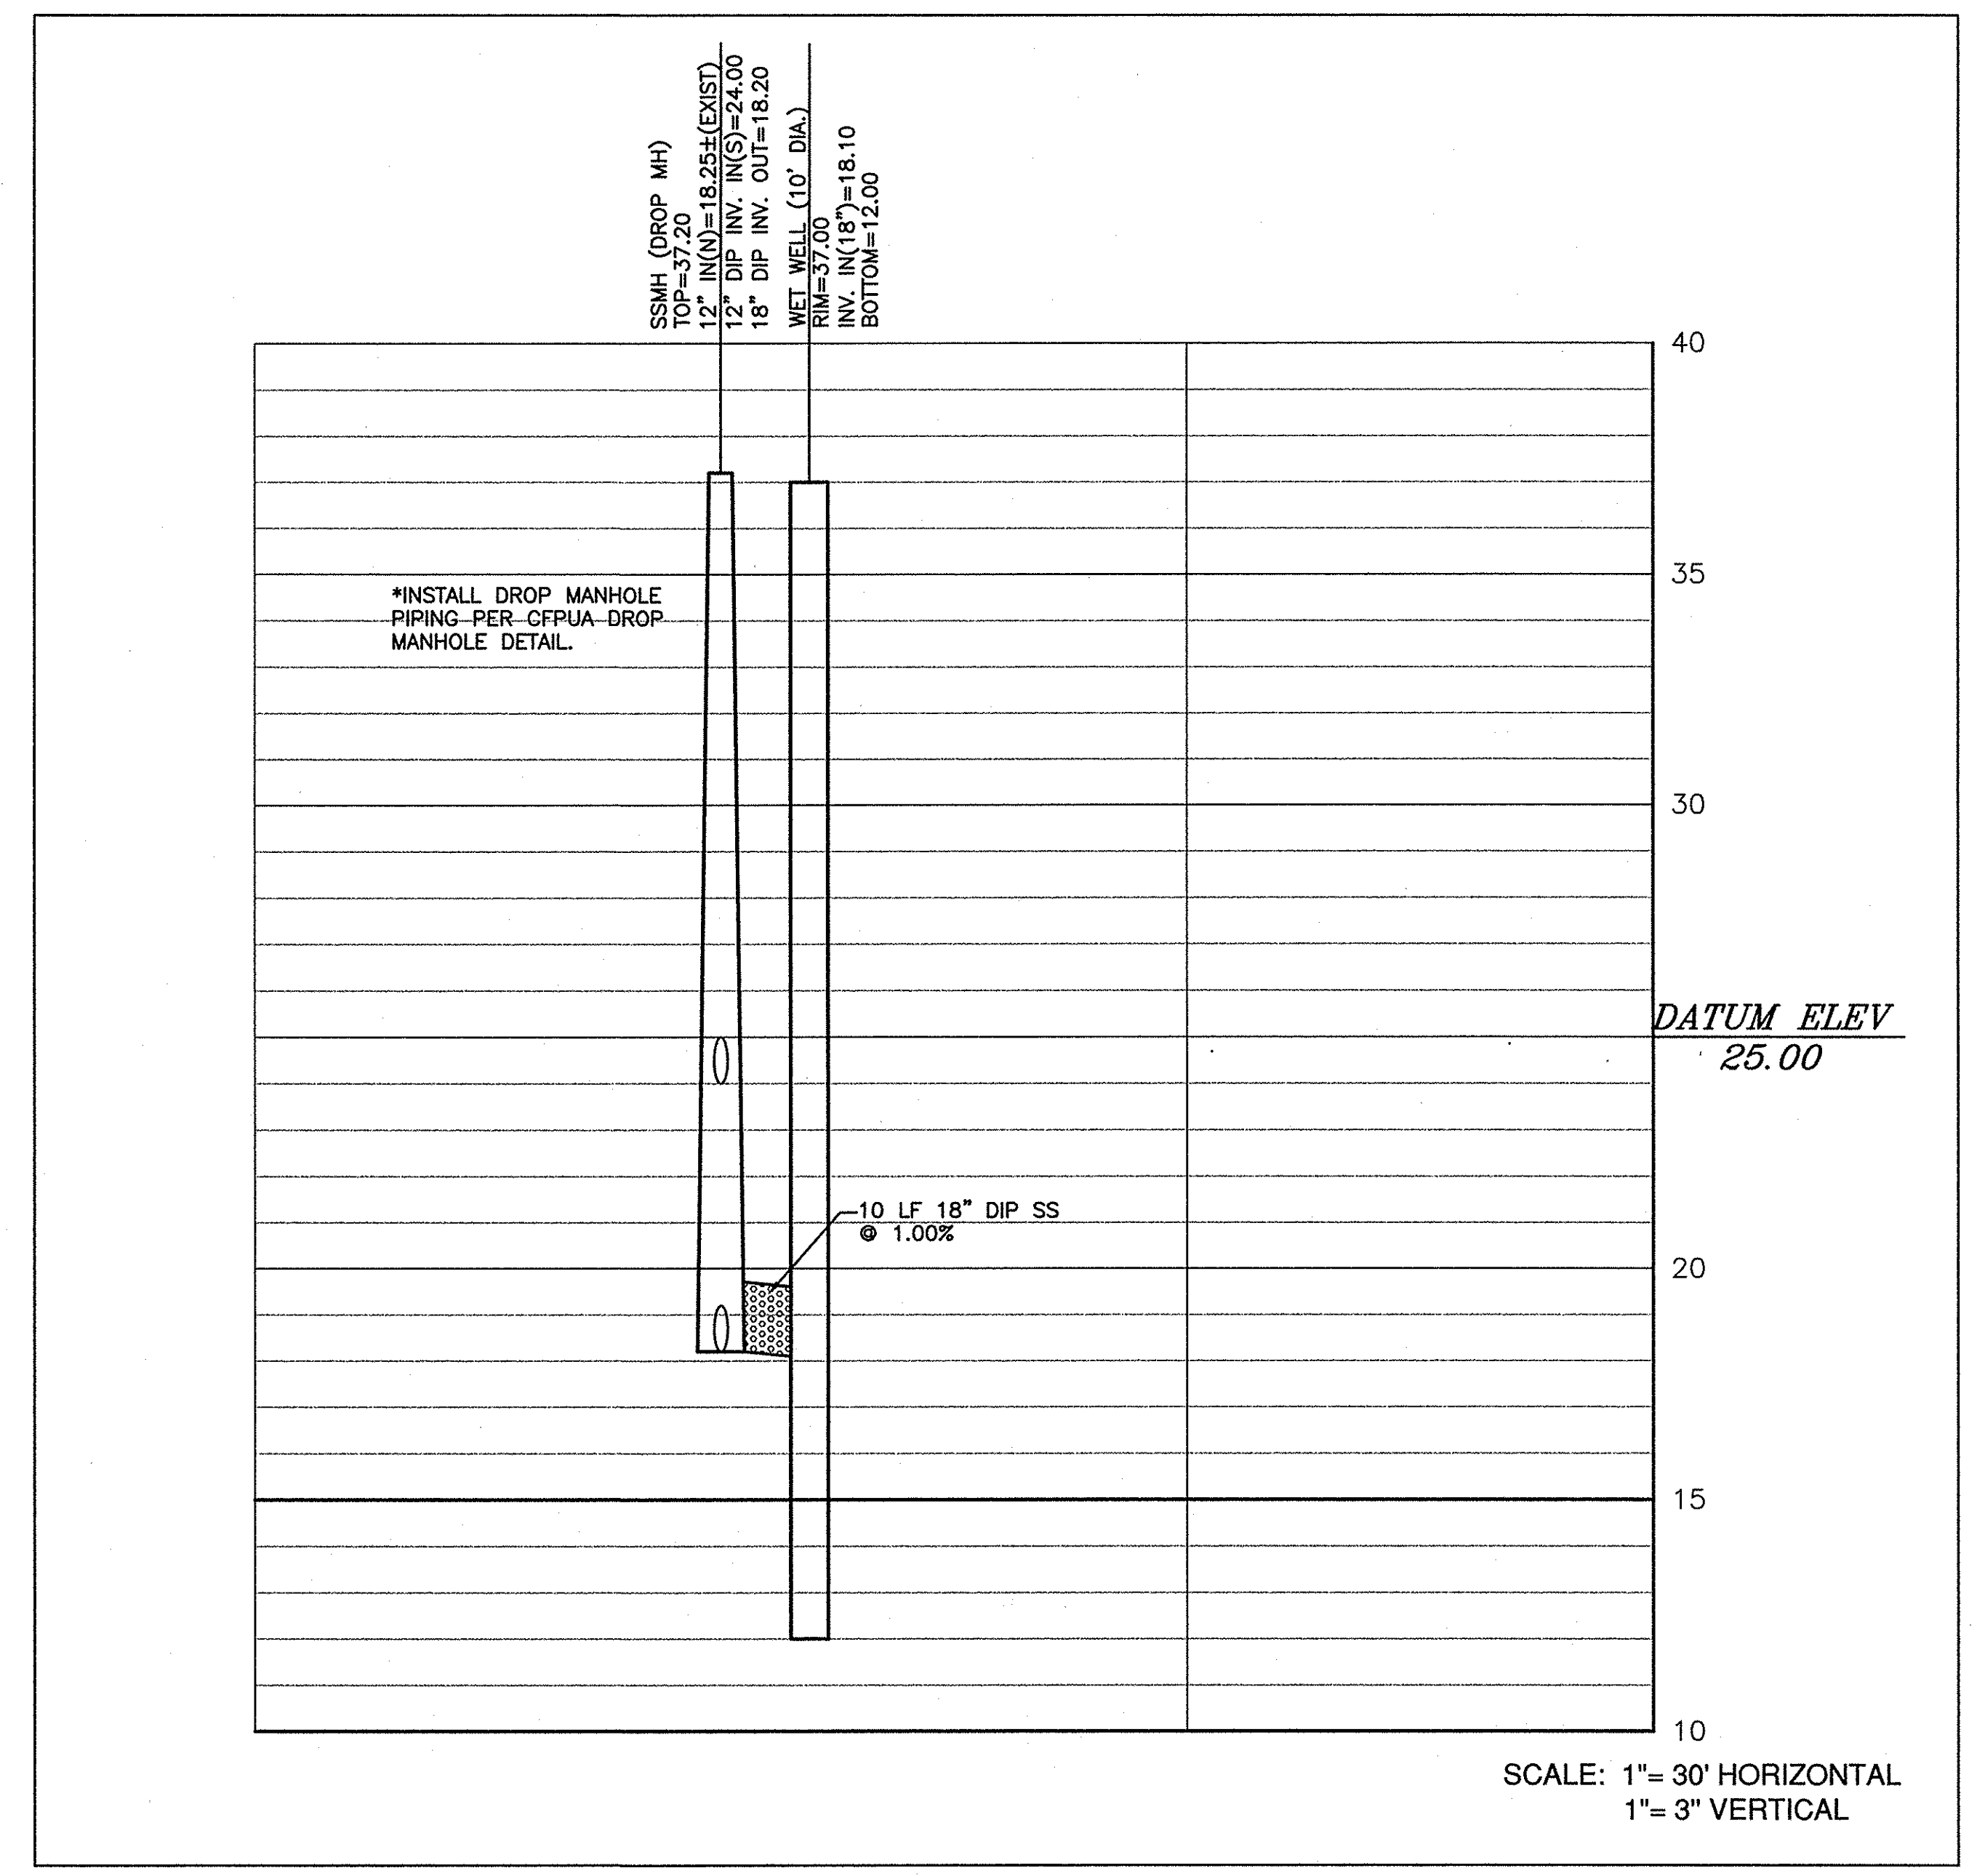
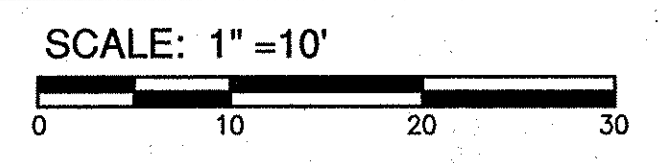
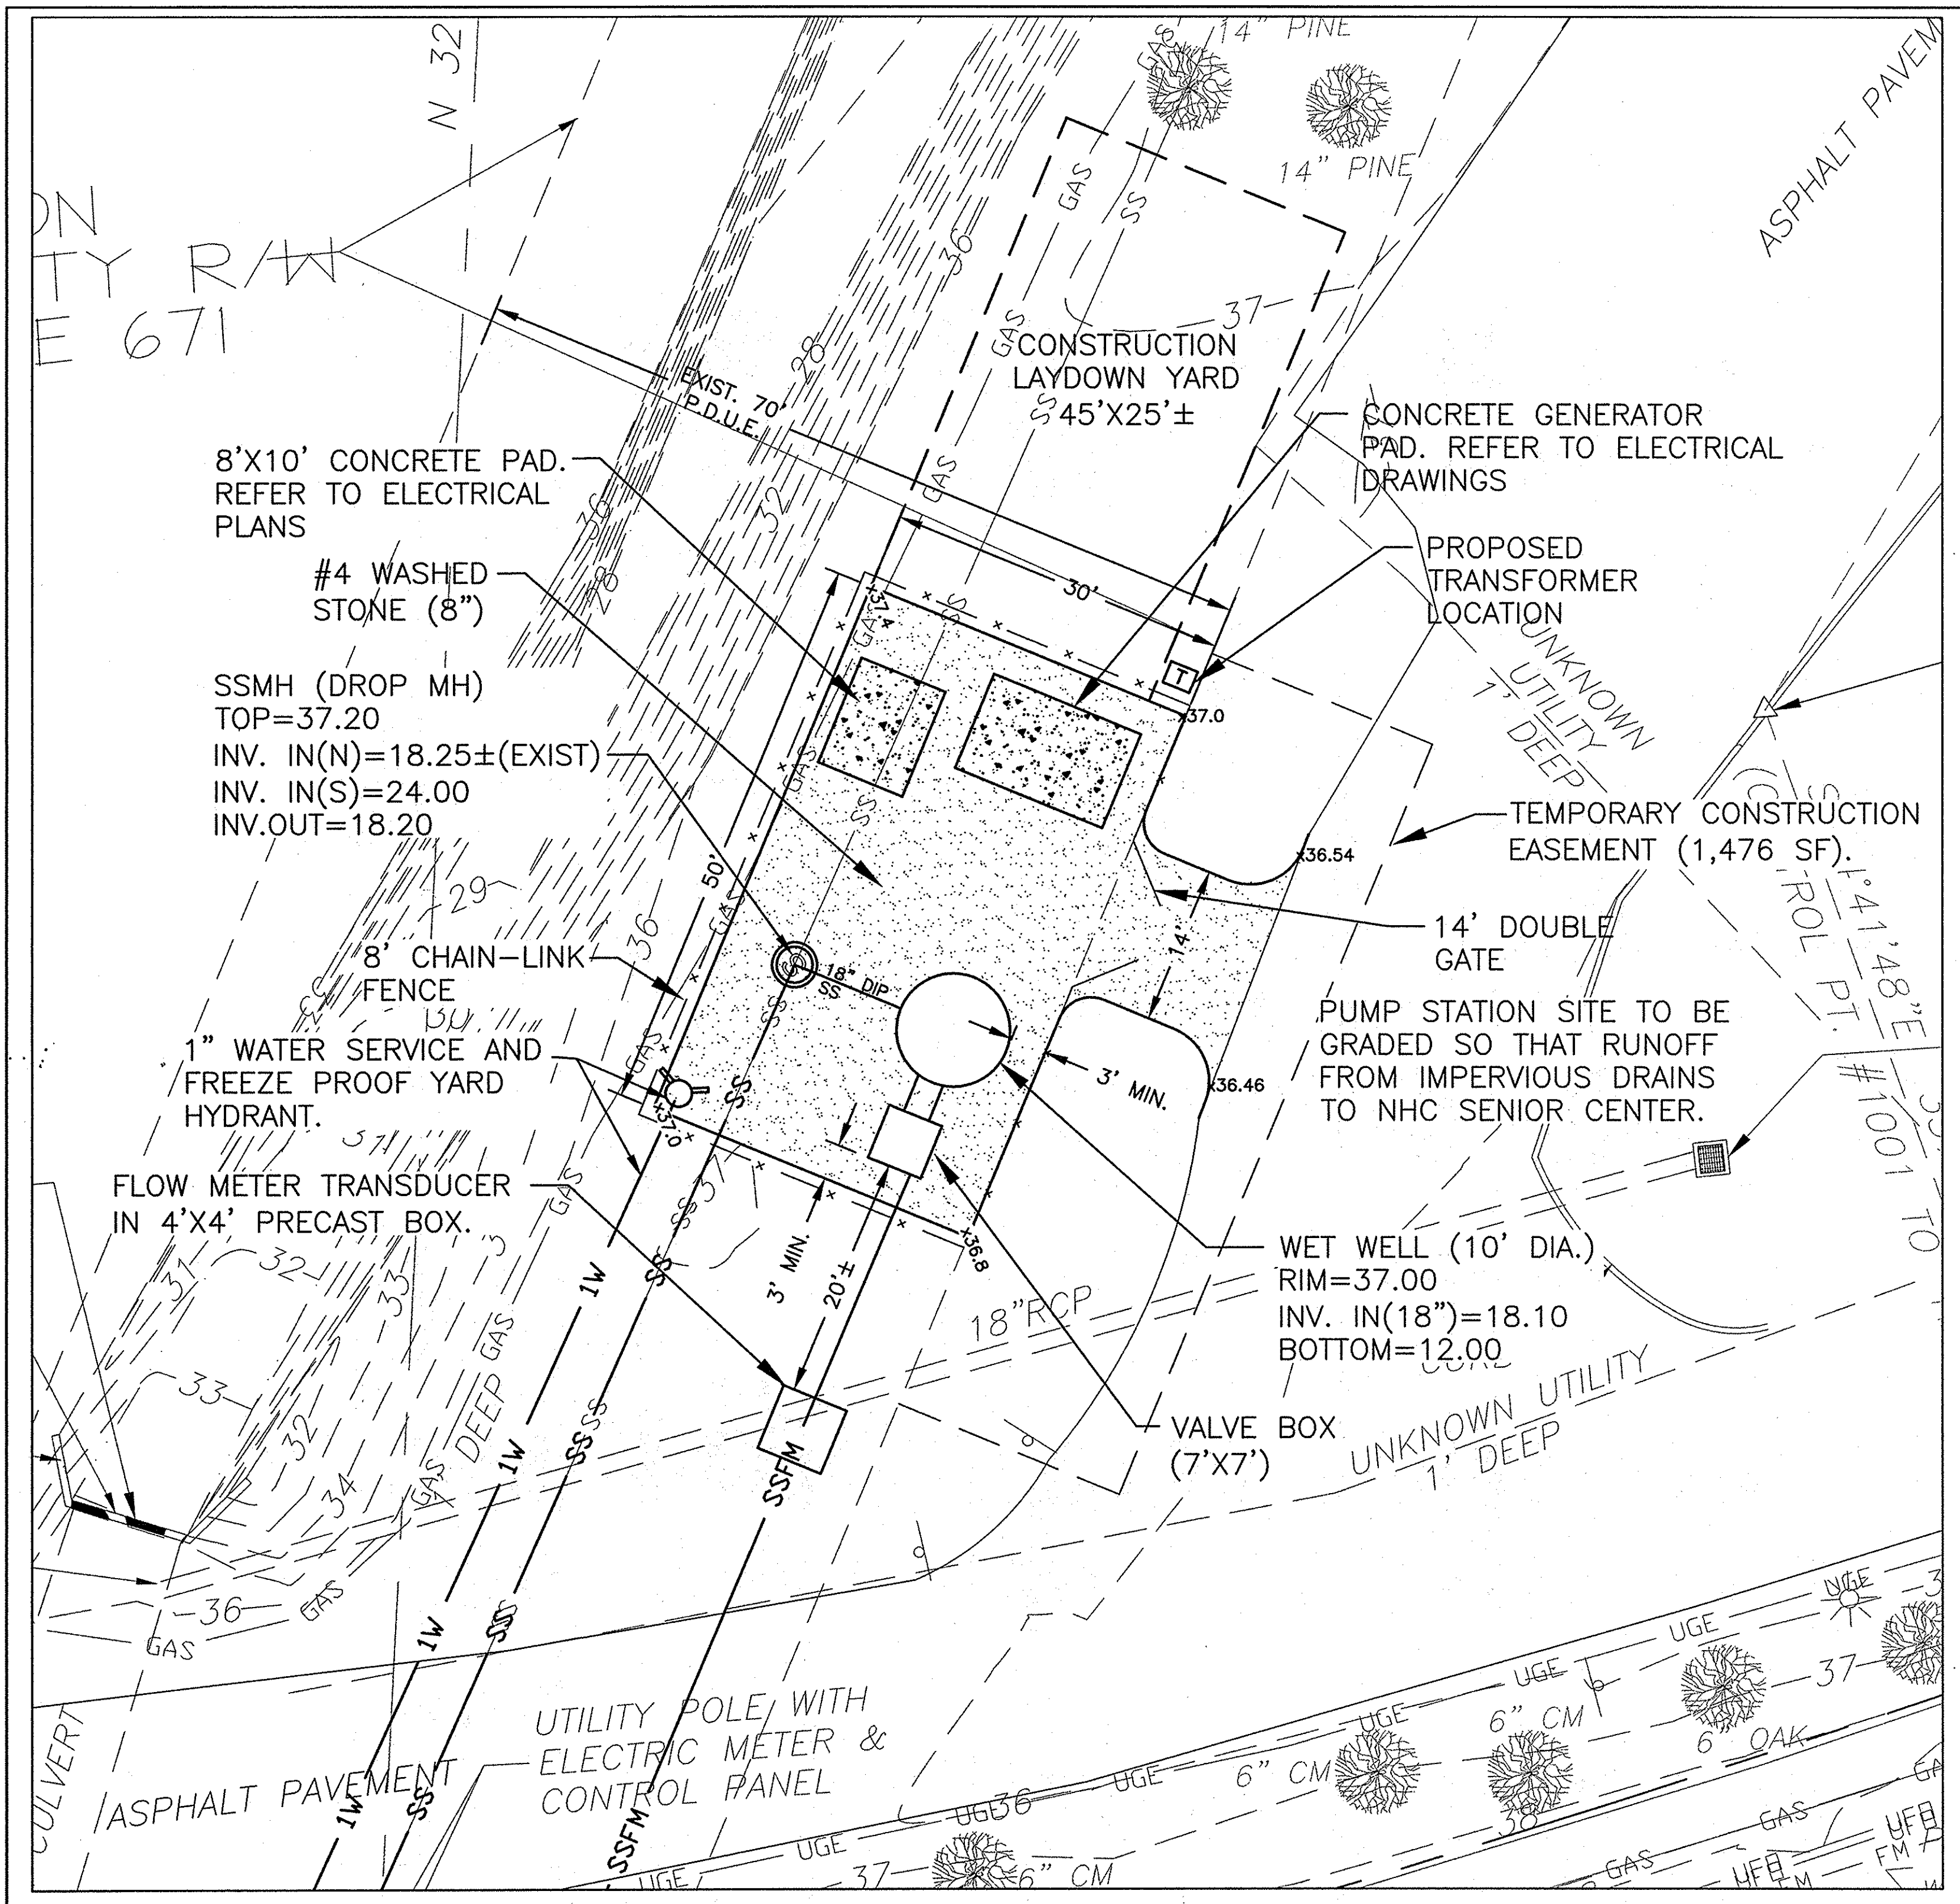


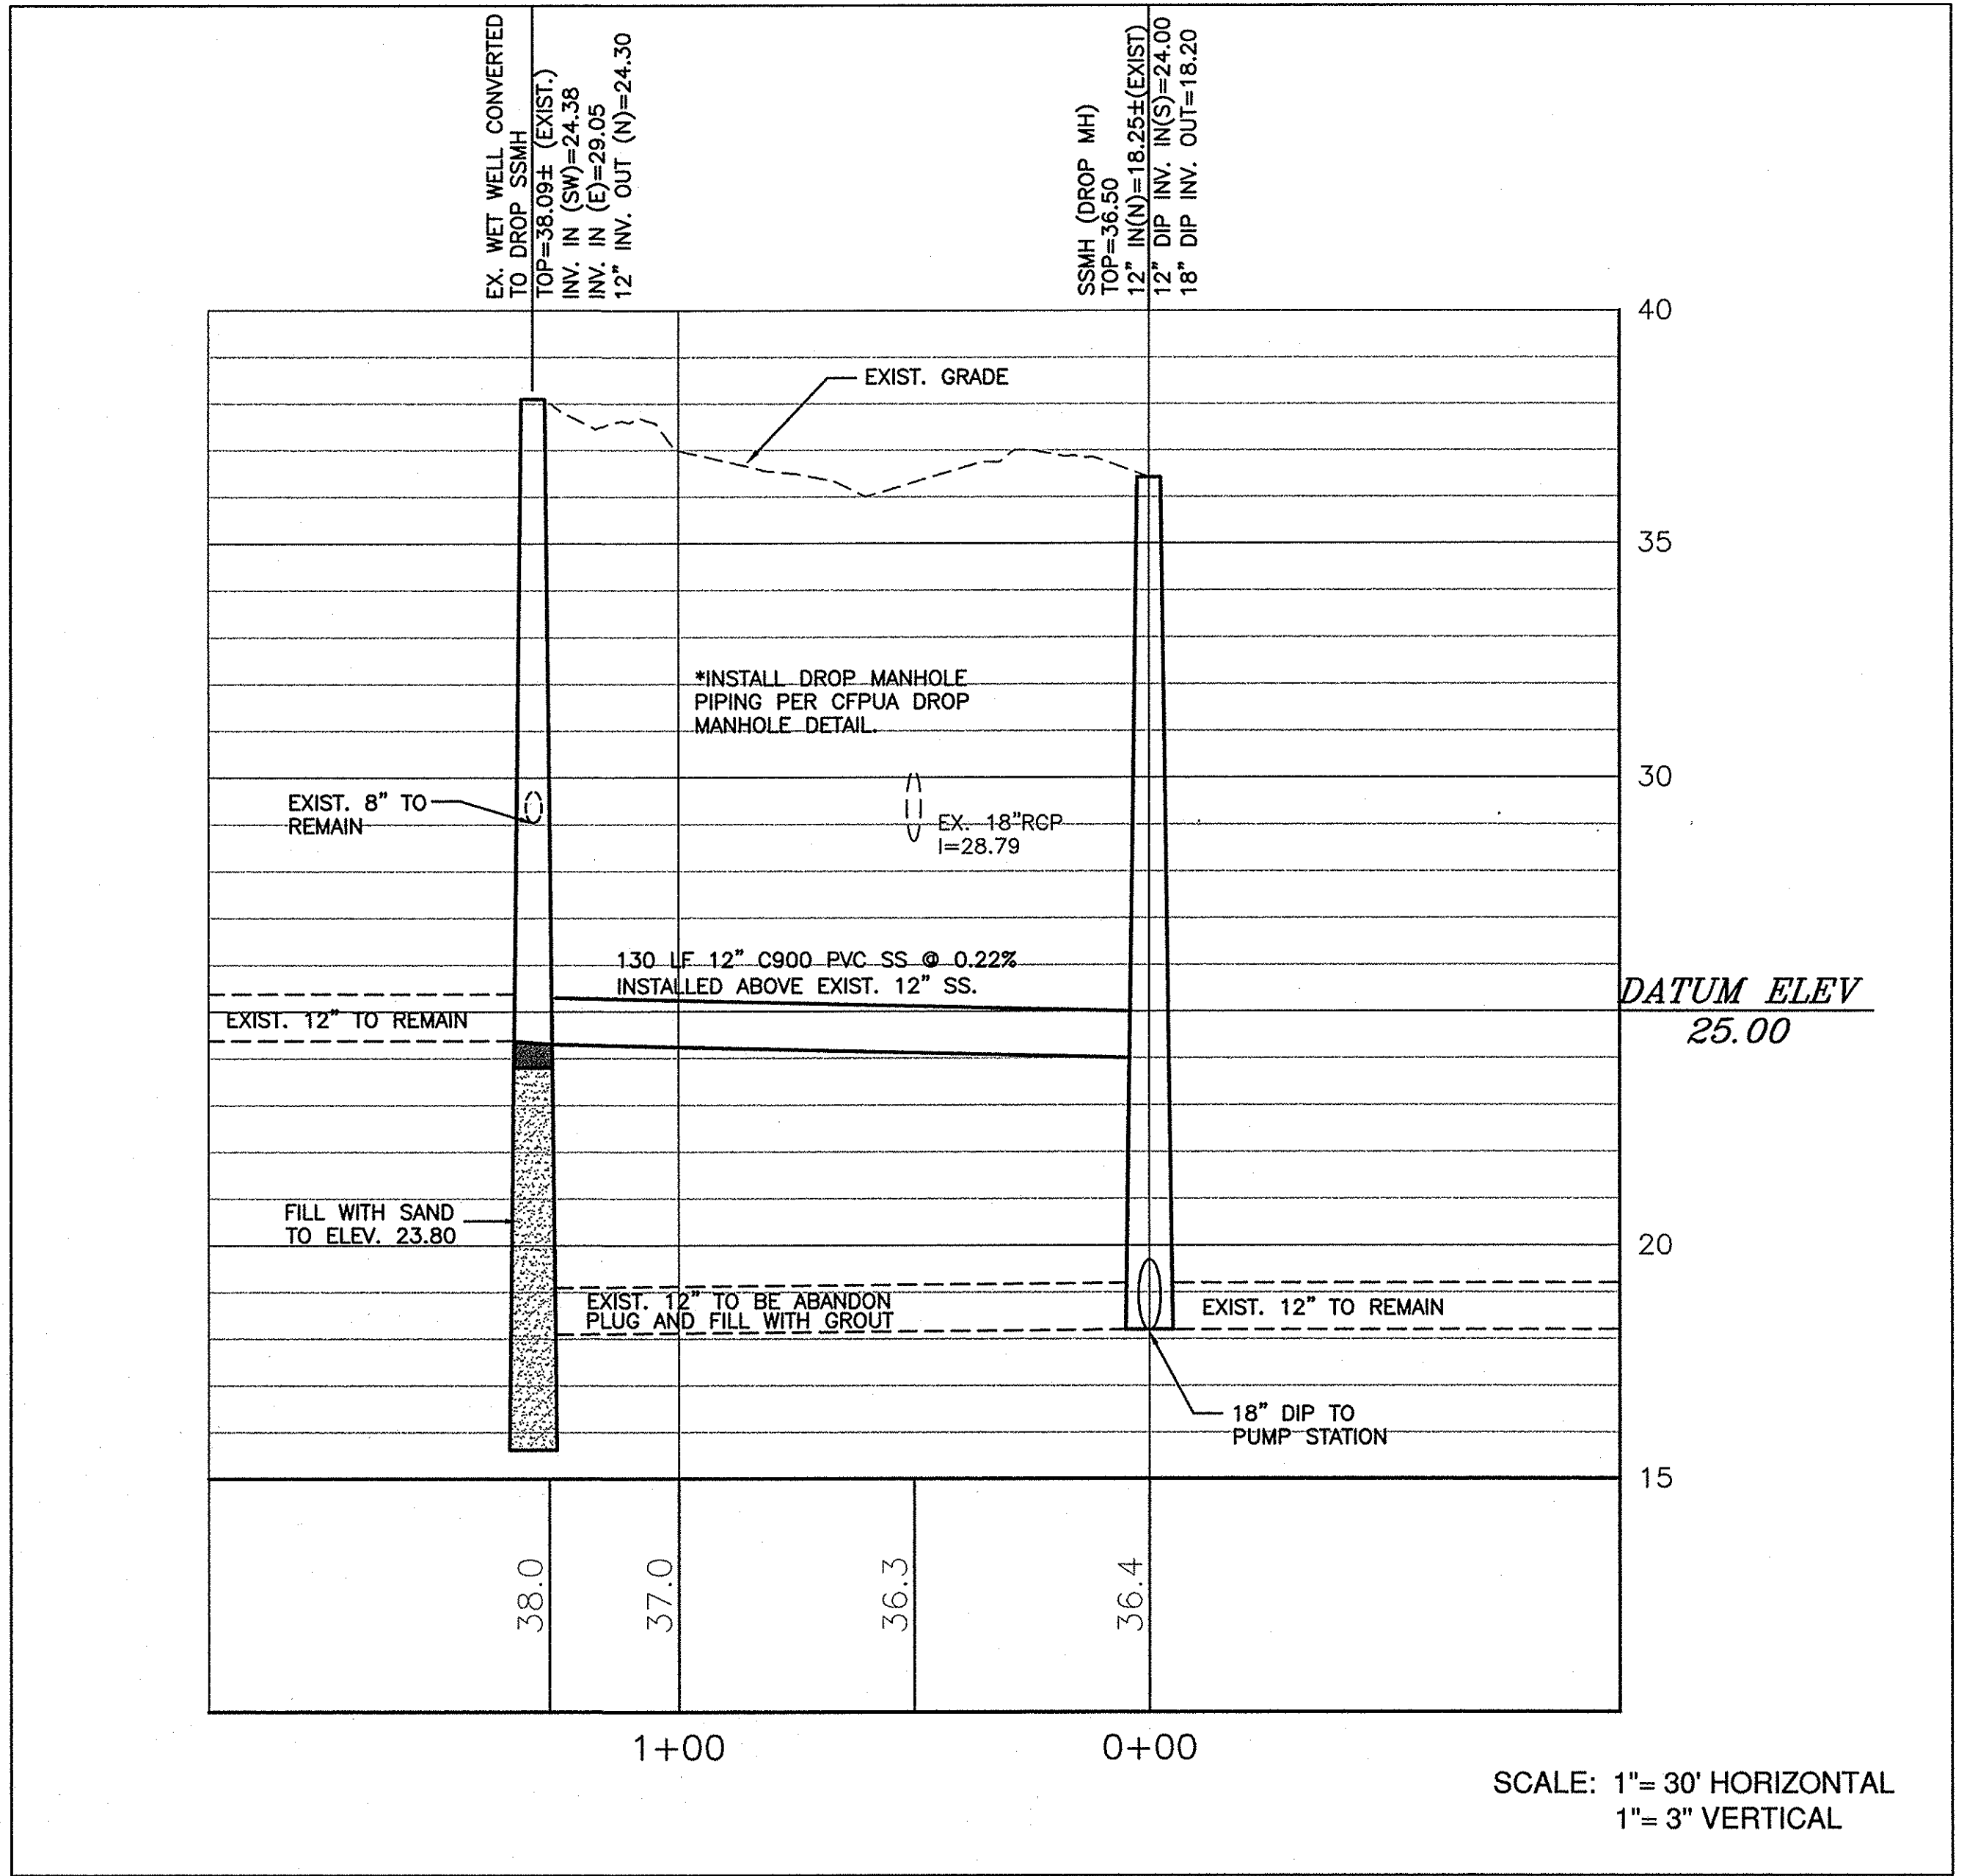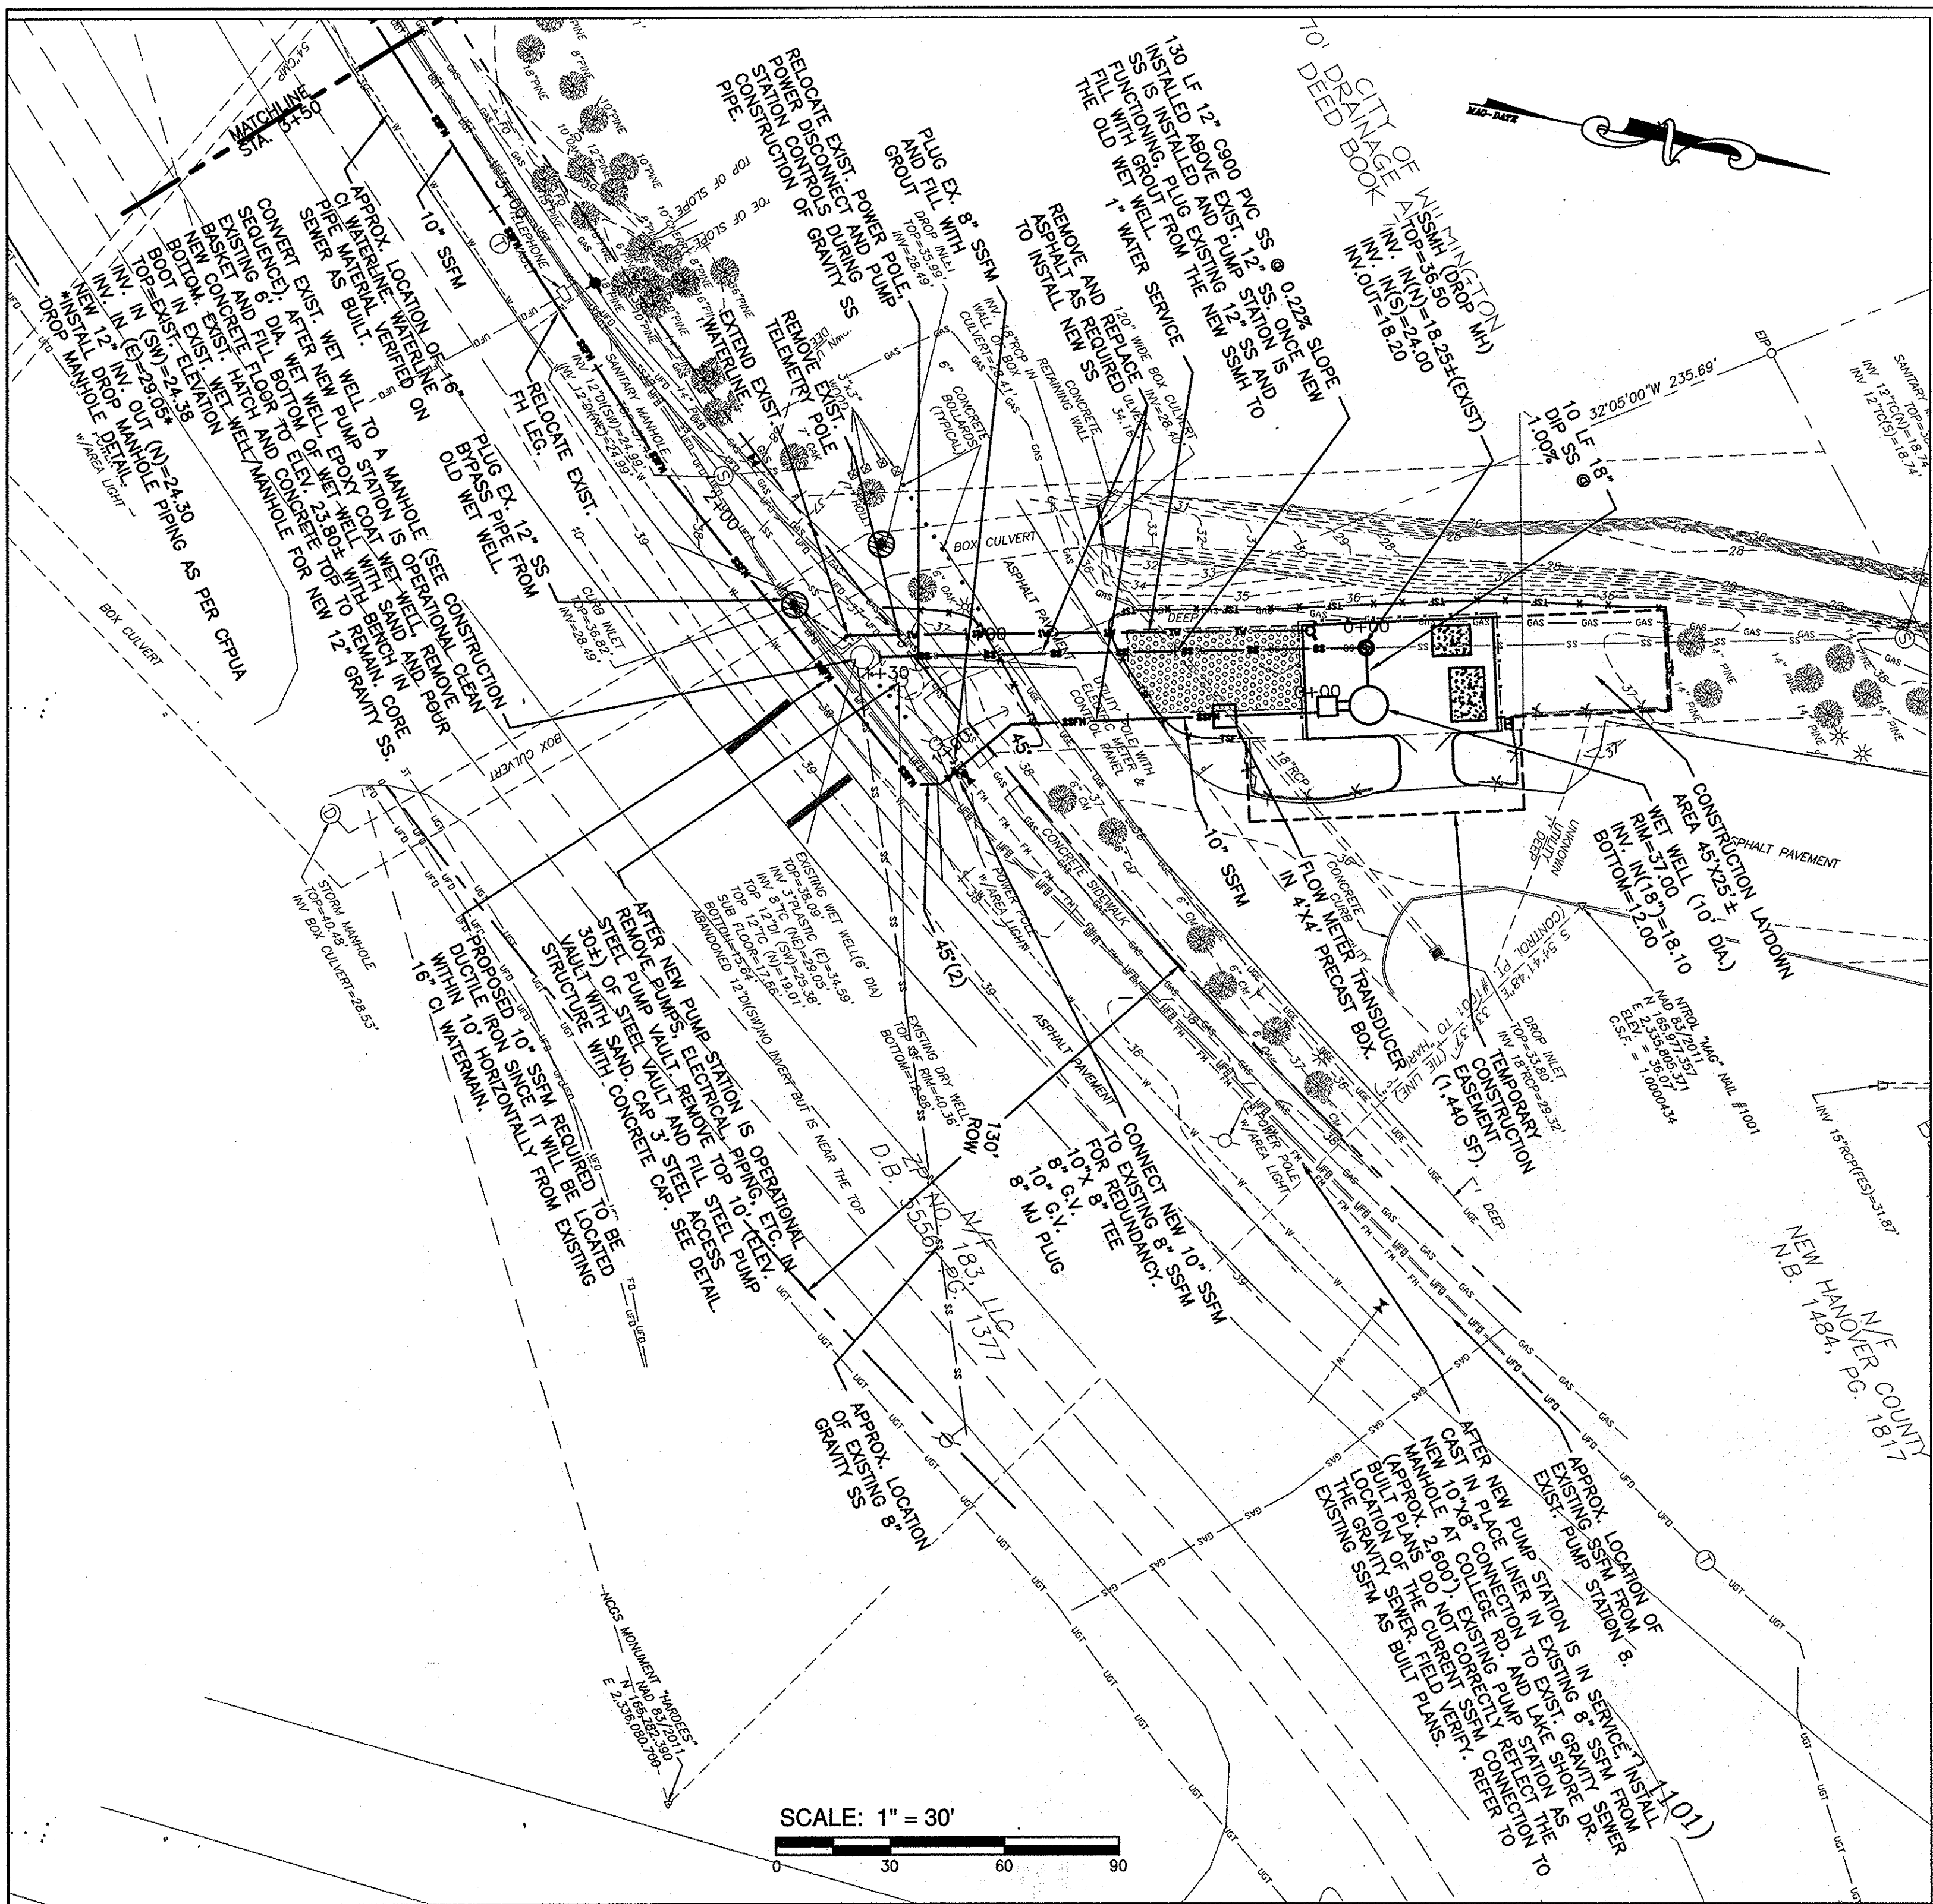**NORRIS & TUNSTALL**  
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 902 MARKET STREET WILMINGTON, NC 28401  
 PHONE (910) 343-0653 FAX (910) 343-0604  
 License #2-0520

**PLAN AND PROFILE**  
**PUMP STATION 8 DESIGN**  
**SHIPYARD BOULEVARD**  
**NEW HANOVER COUNTY**

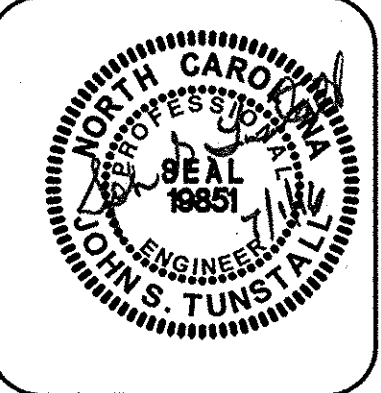
DATE: 6/28/16  
 SCALE: 1" = 30'  
 1" = 3'  
 DRAWN: NKS  
 CHECKED: JST  
 PROJECT NO: 15048

SHEET NO:  
**PR3**



SCALE: 1" = 30' HORIZONTAL  
1" = 3" VERTICAL

REV. NO.	DESCRIPTION	DATE

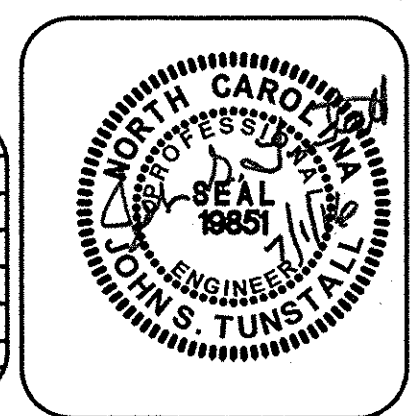

**NORRIS & TUNSTALL**  
CONSULTING ENGINEERS, INC.  
902 MARKET STREET WILMINGTON, NC 28401  
PHONE (910) 343-9853 FAX (910) 343-9804  
LICENSE #2-6520

PLAN AND PROFILE  
PUMP STATION 8 DESIGN  
SHIPYARD BOULEVARD  
NEW HANOVER COUNTY

DATE: 6/28/16  
SCALE: 1" = 30'  
1" = 3'  
DRAWN: NKS  
CHECKED: JST  
PROJECT NO: 15048











SHEET NO:  
**PR4**

I:\Projects\2015\15048\_PSP\_Design (Task 2)\15048\_Plan\dwg\15048.master.dwg, 6/28/2016 2:14:07 PM




PUMP INFORMATION		
MANUFACTURER	MYERS	
MODEL #	AVCX WITH VFD	
HORSEPOWER	50	
PHASE	3	VOLTS
	VARIABLE	TDH
	12"	IMPELLER DIAMETER

ITEM	DIM.	DESCRIPTION
"A"	12'±	OUTSIDE DIAMETER OF WET WELL
"B"	10'	INSIDE DIAMETER OF WET WELL
"C"	48"	ACCESS HATCH LENGTH (48" MIN.)
"D"	48"	ACCESS HATCH WIDTH (32" MIN.)
"E"	4'	CL PUMP TO CL PUMP DIMENSION
"F"	7'	CL HATCH TO OUTSIDE OF WET WELL
"G"	6'	CL HATCH TO INSIDE OF WET WELL
"H"	8"	PIPE DIAMETER
"I"	36"	CL PIPE TO CL PIPE DIMENSION 30" MIN (4") 36" MIN (6")
"J"	84"	VALVE PIT WIDTH 60" MIN (4") 84" MIN (6")
"K"	84"	VALVE PIT LENGTH 60" MIN (4") 84" MIN (6")
"L"	60"	ACCESS HATCH LENGTH (48" MIN)
"M"	60"	ACCESS HATCH WIDTH (48" MIN)
"N"	18"	INFLUENT PIPE SIZE
"O"	10"	FORCE MAIN PIPE SIZE (4" MIN)

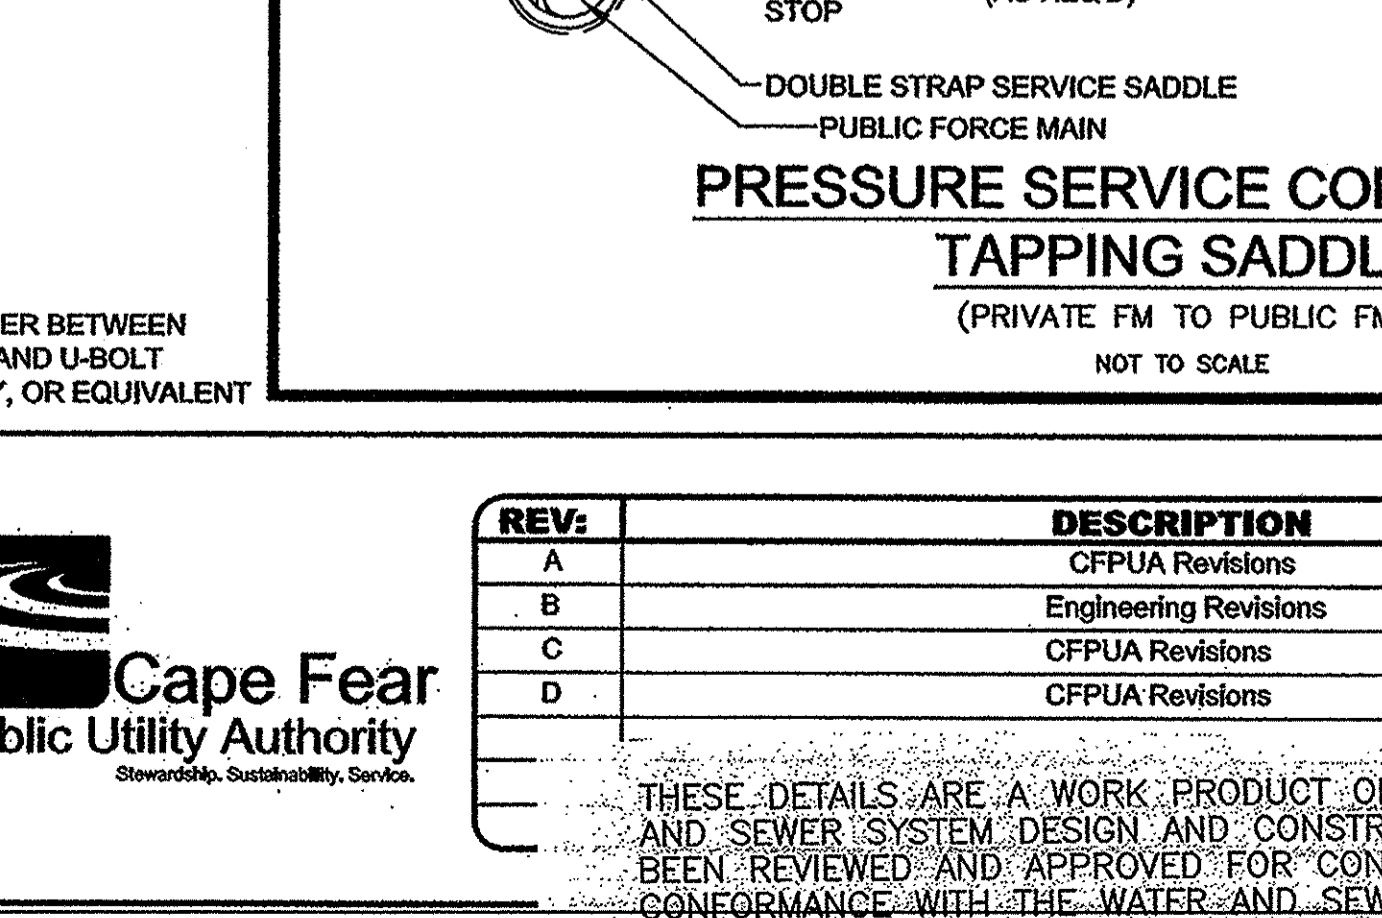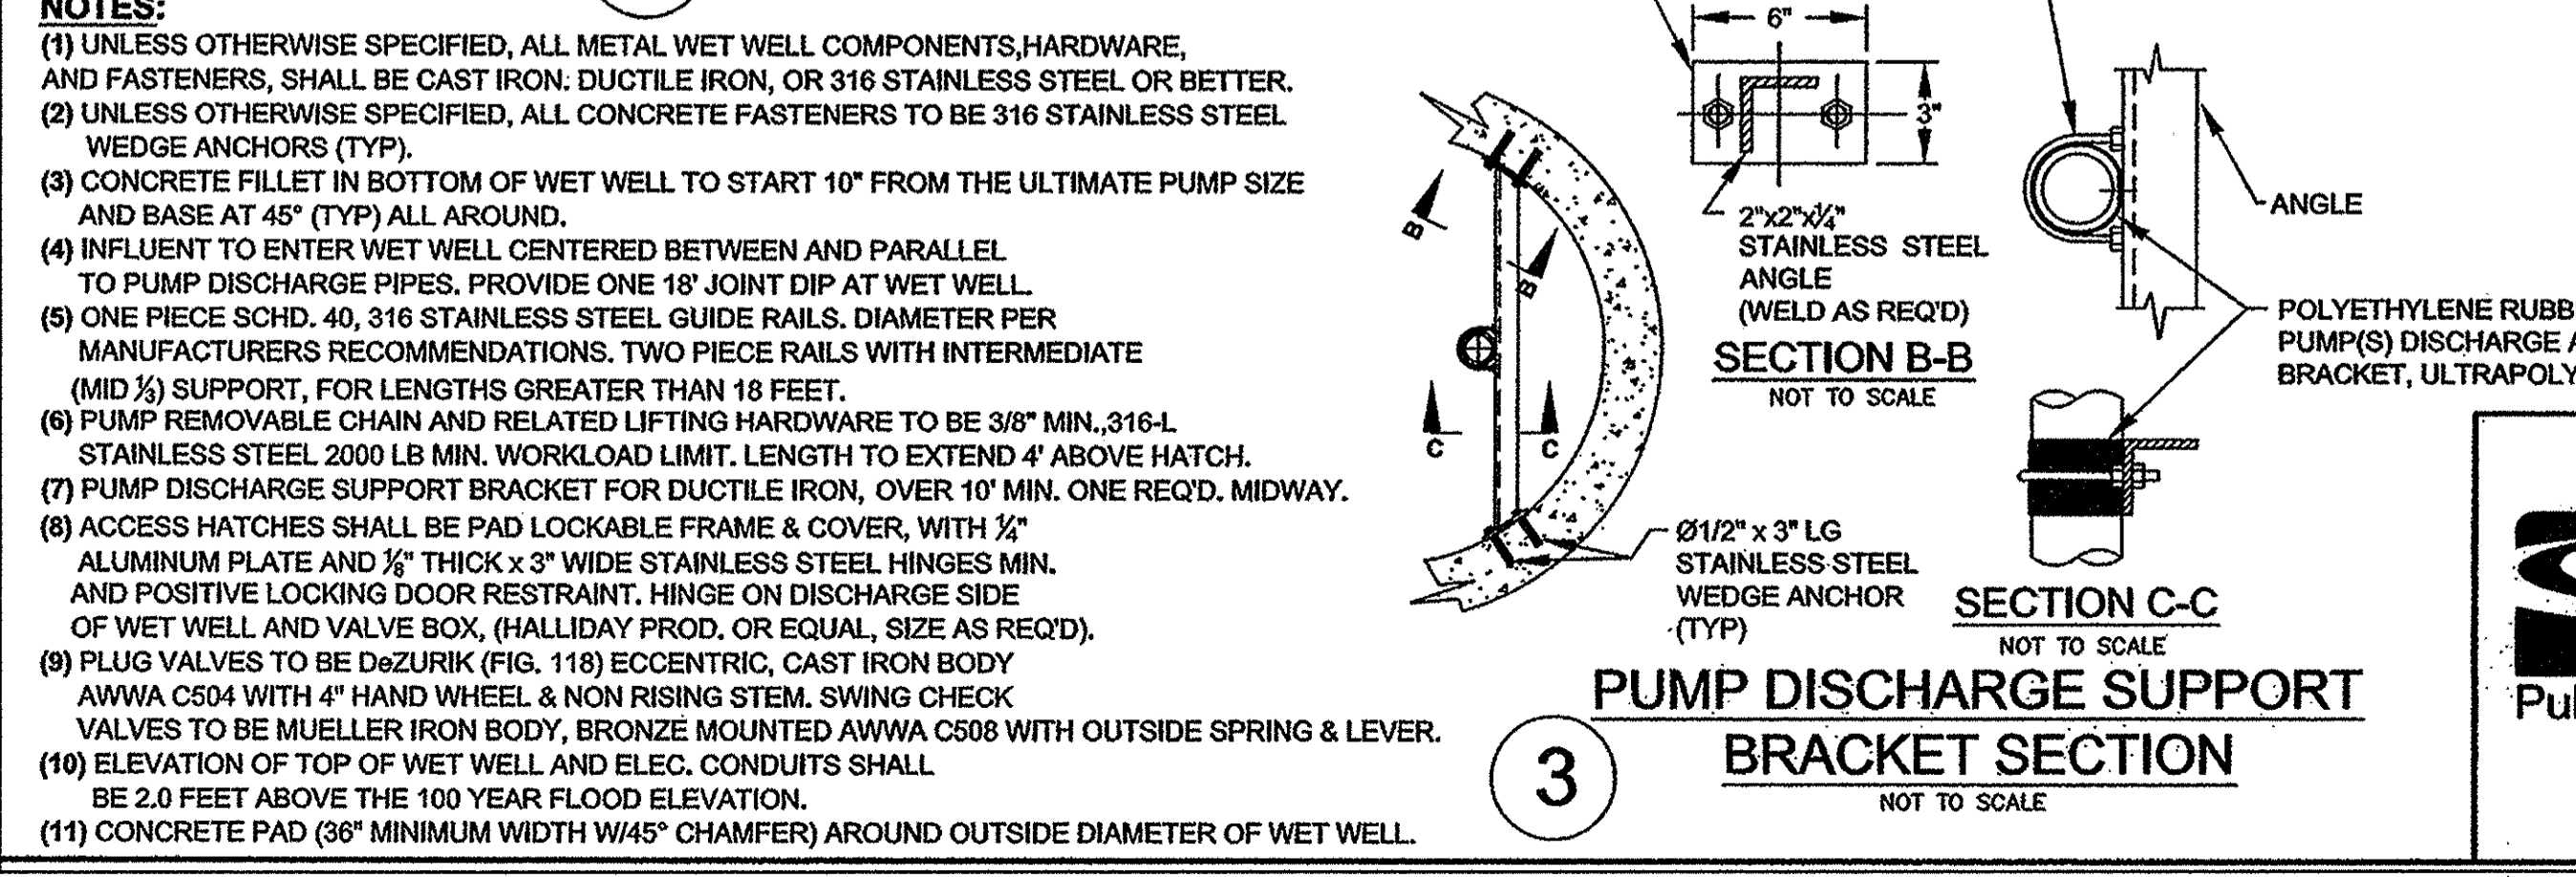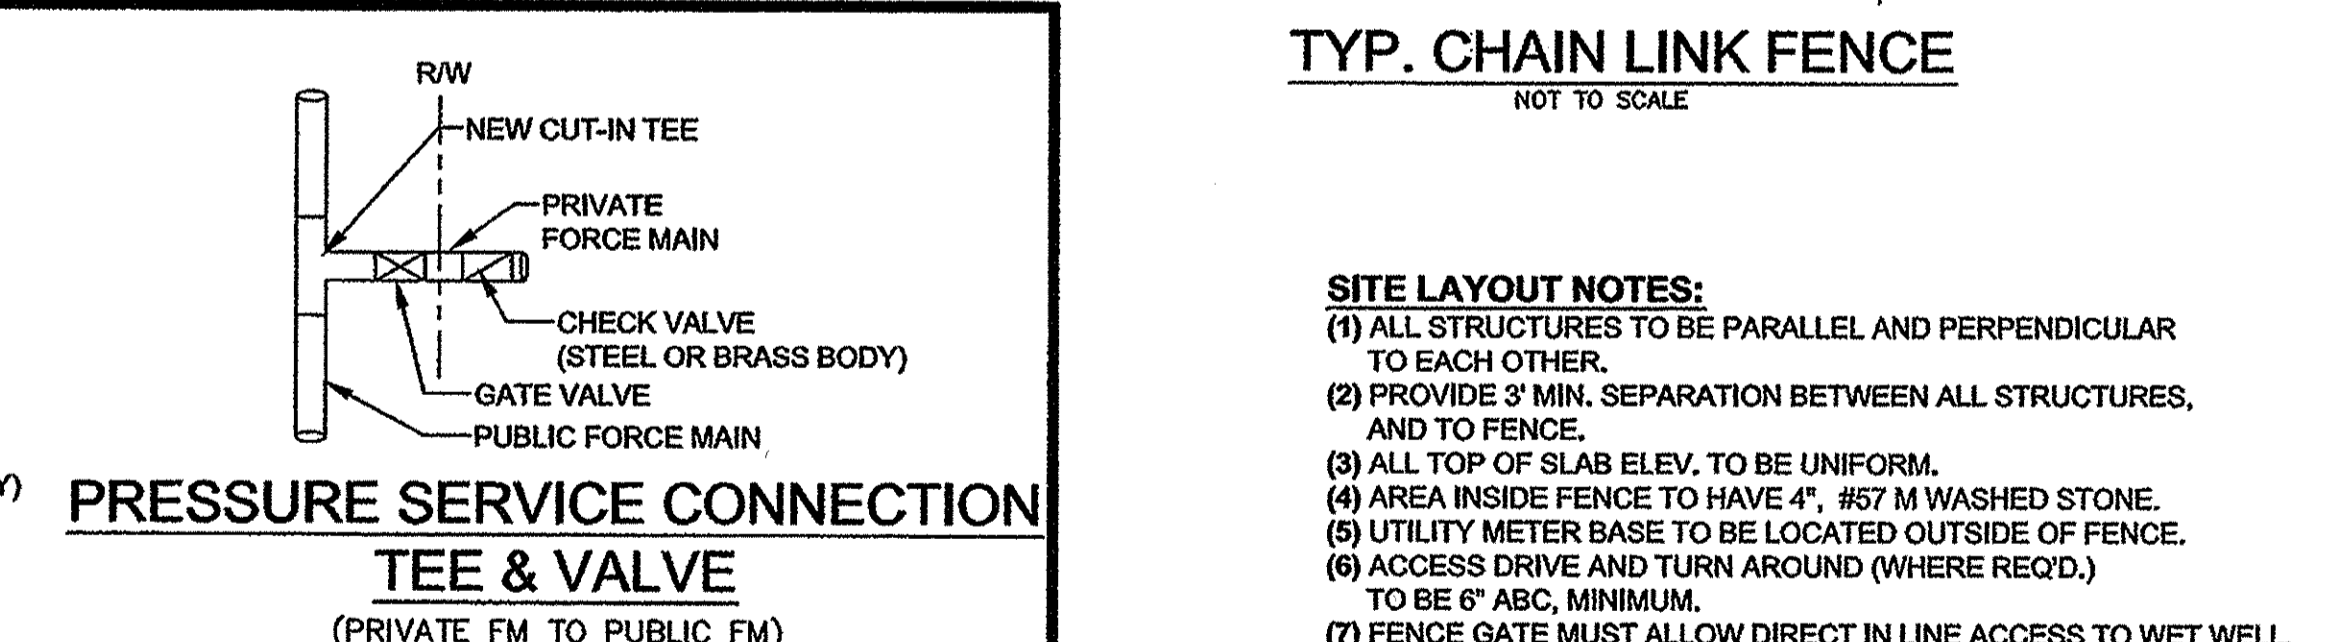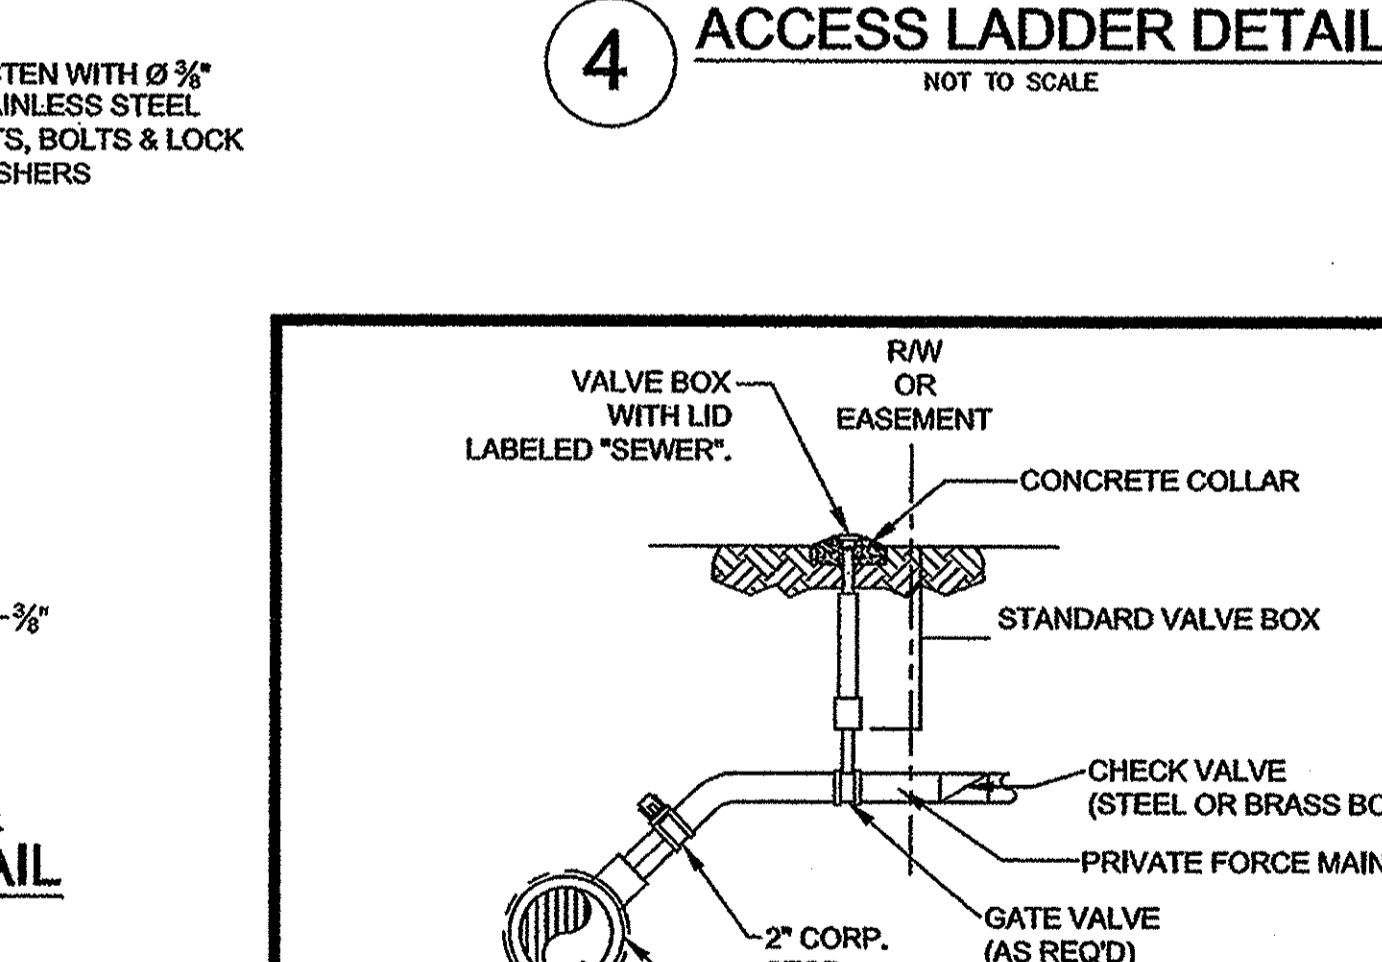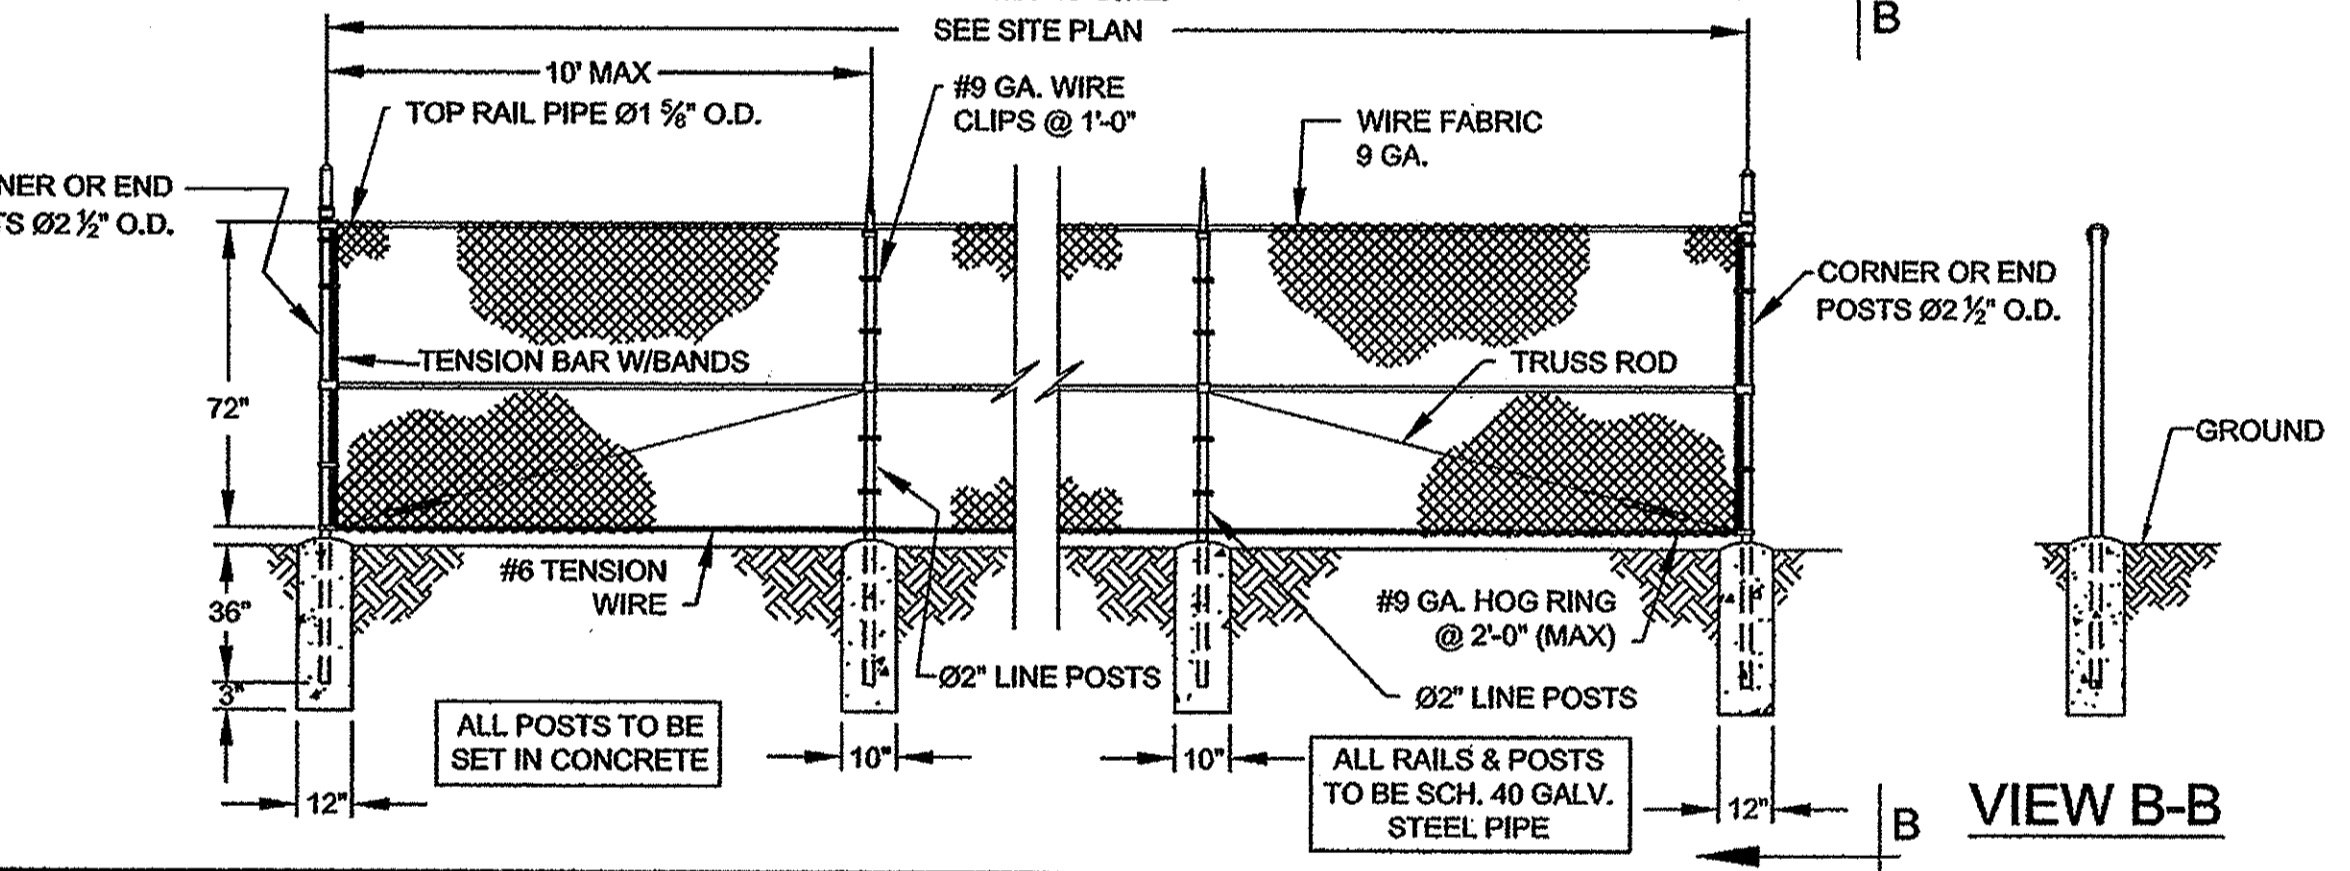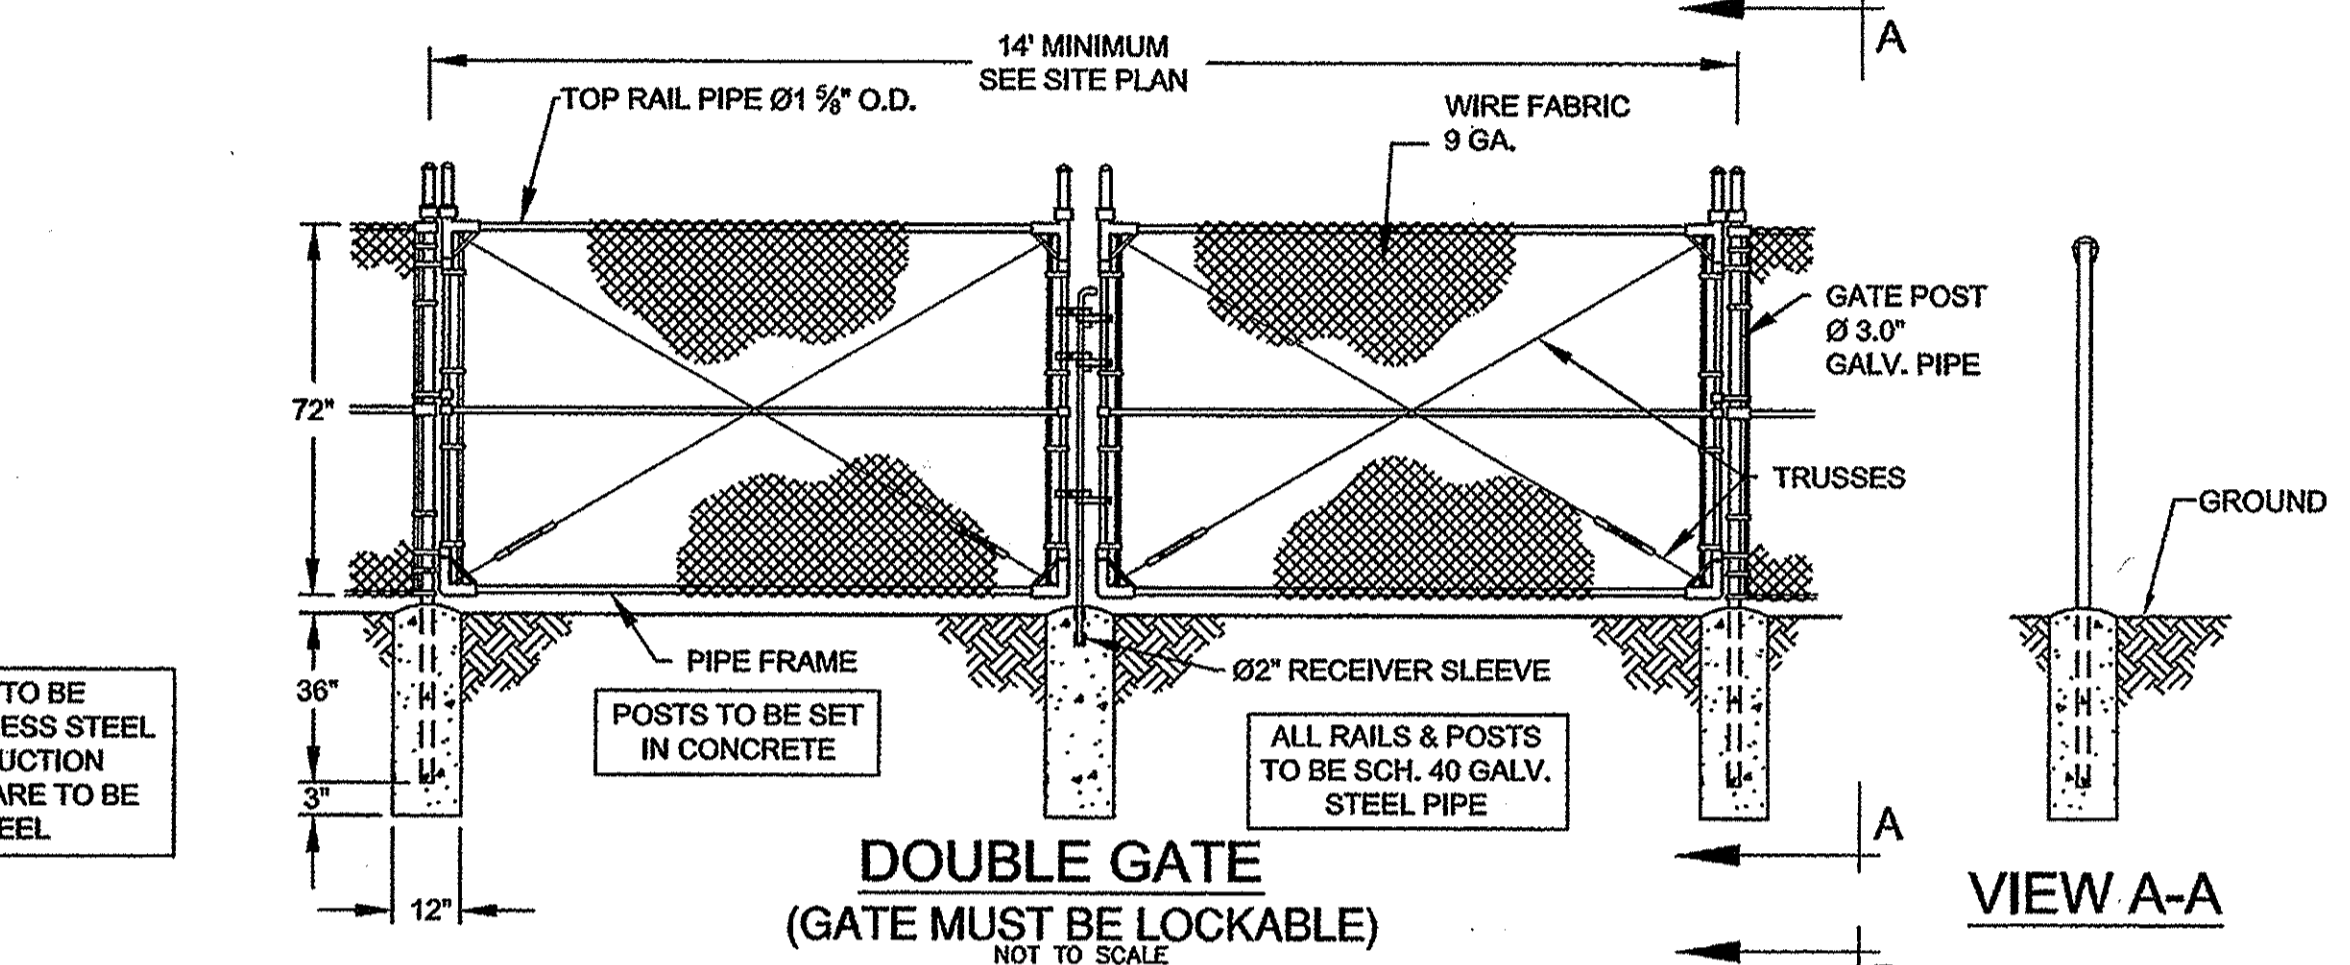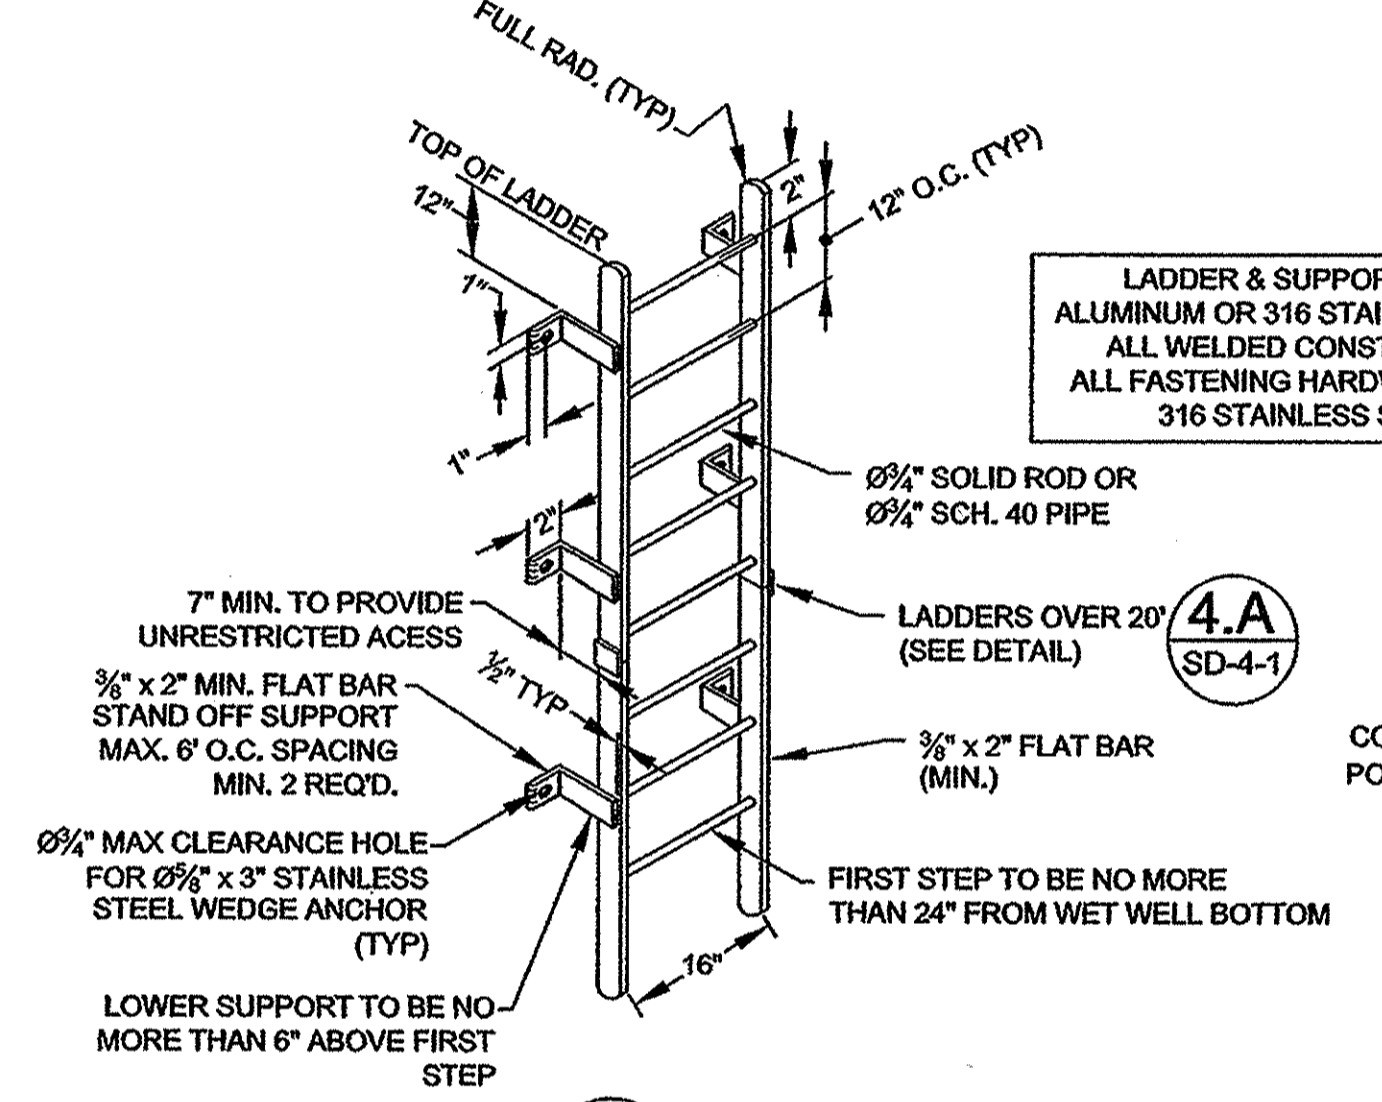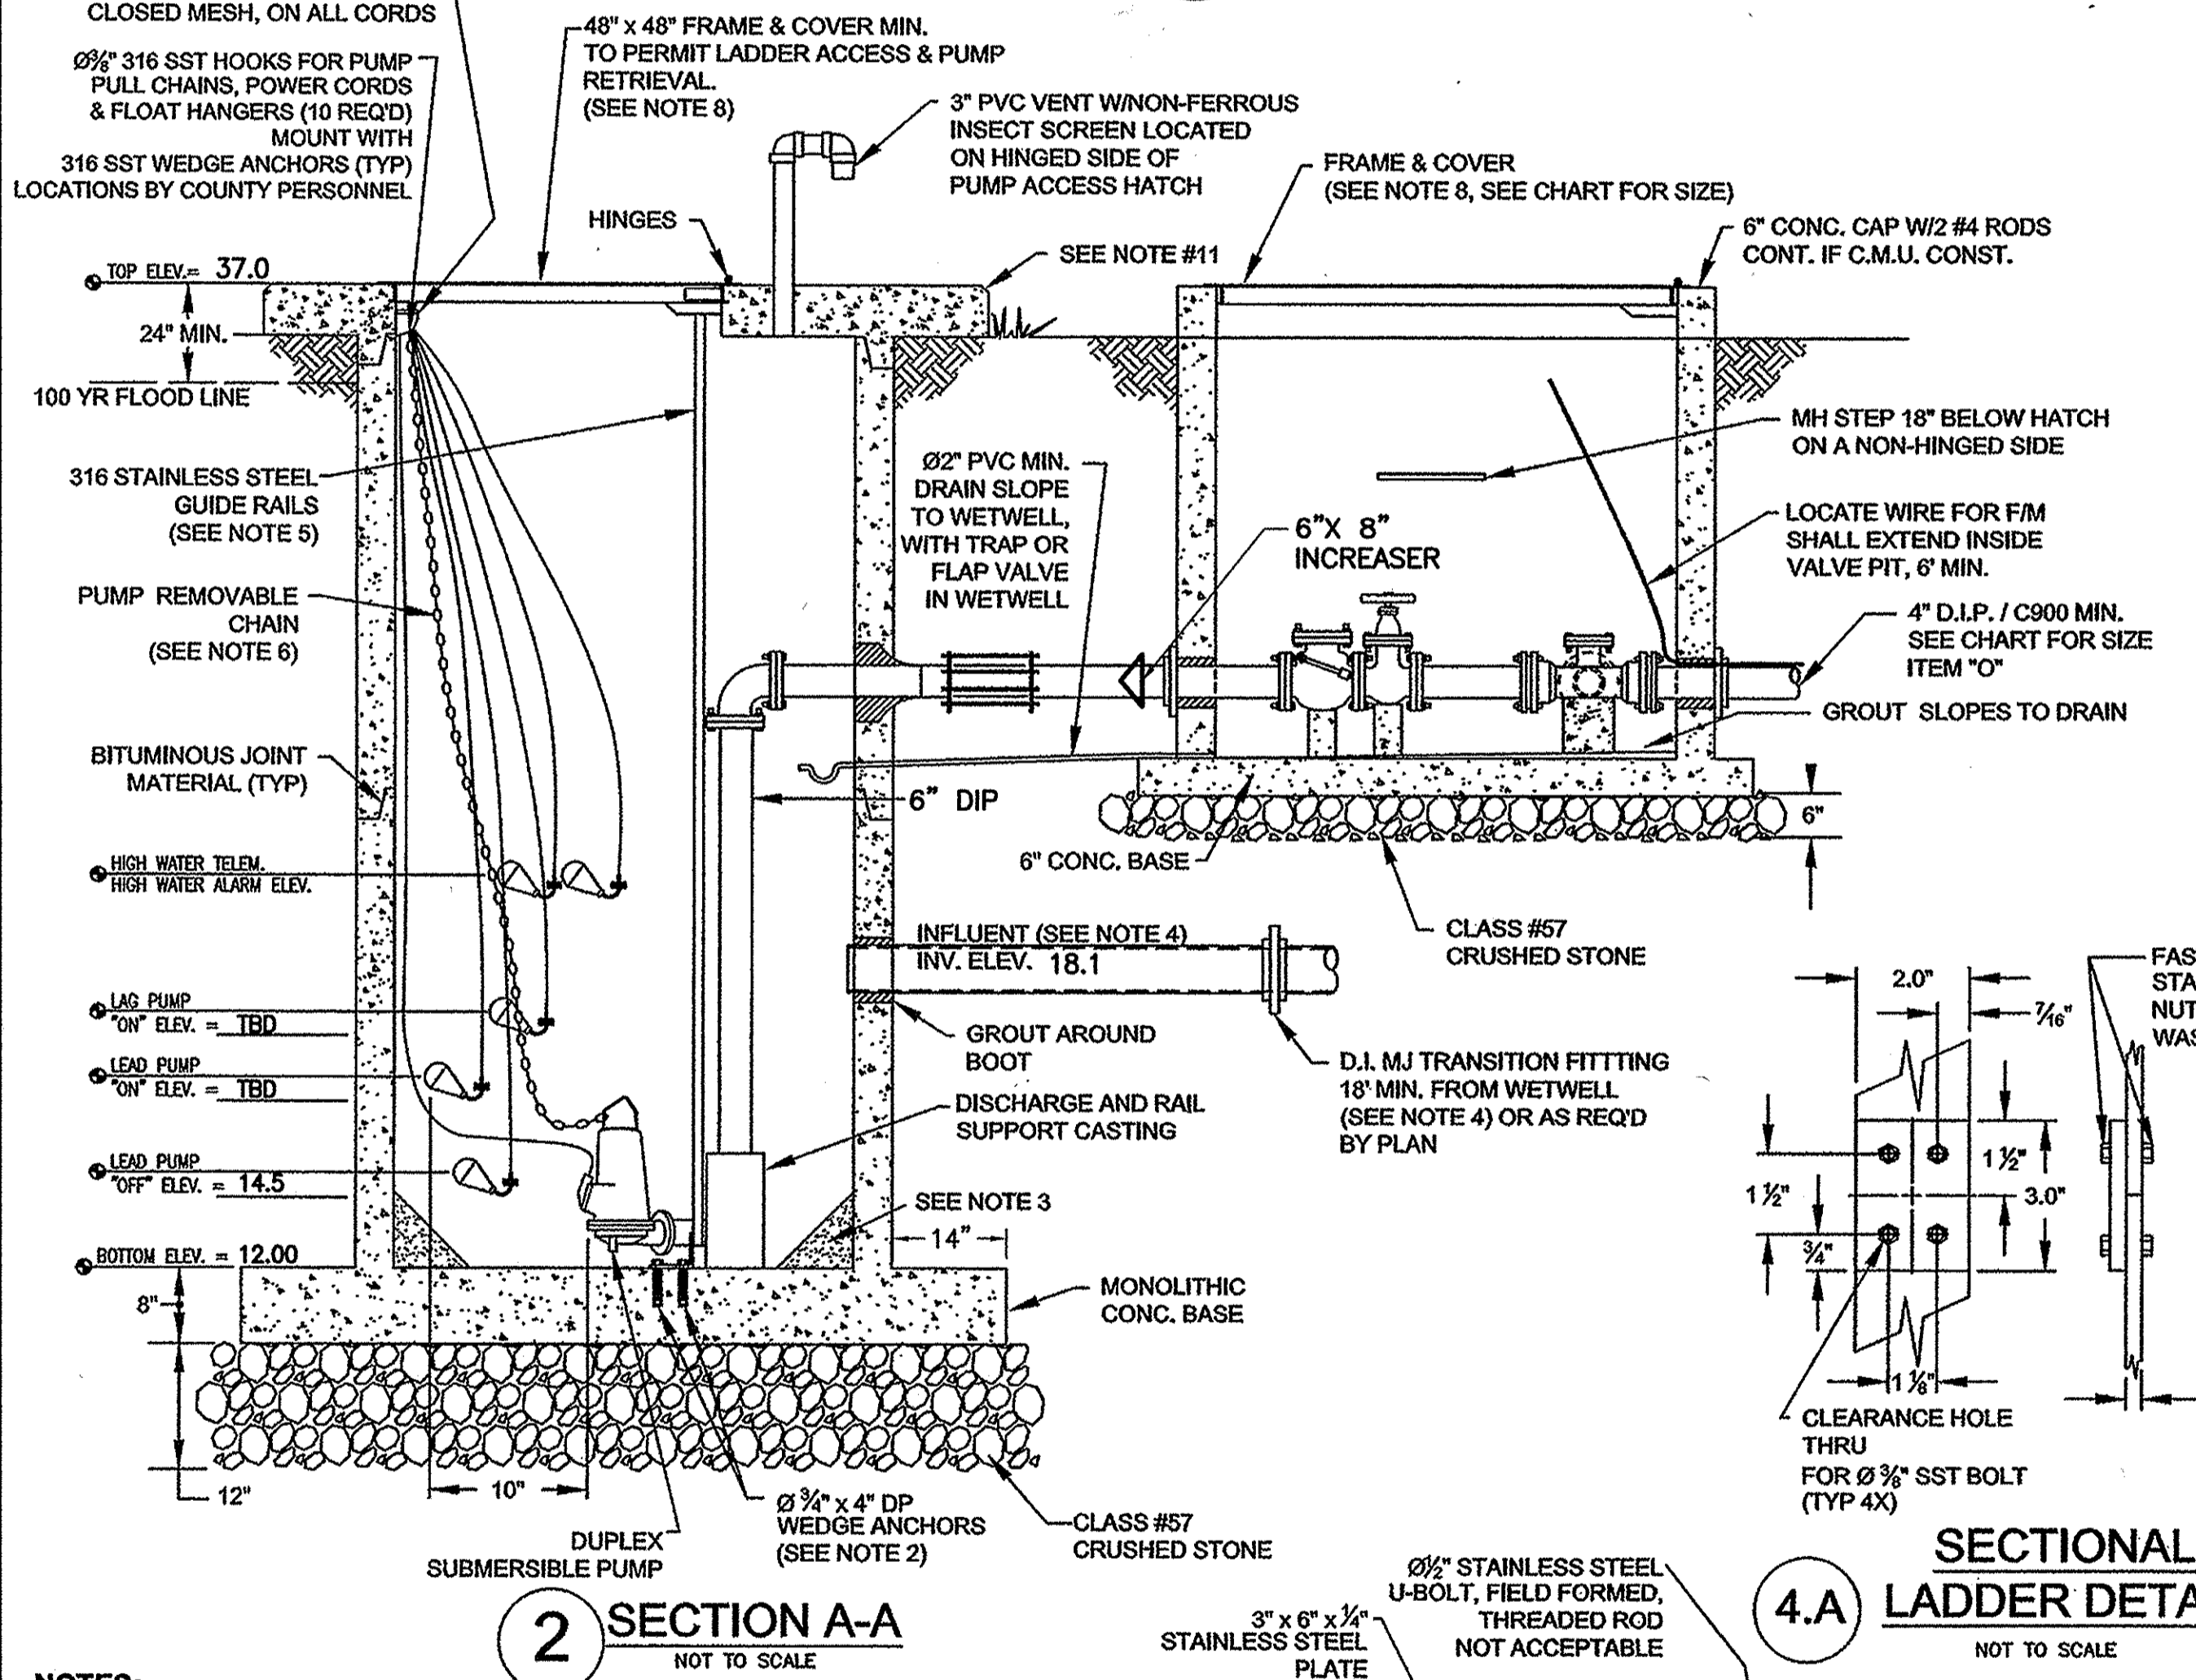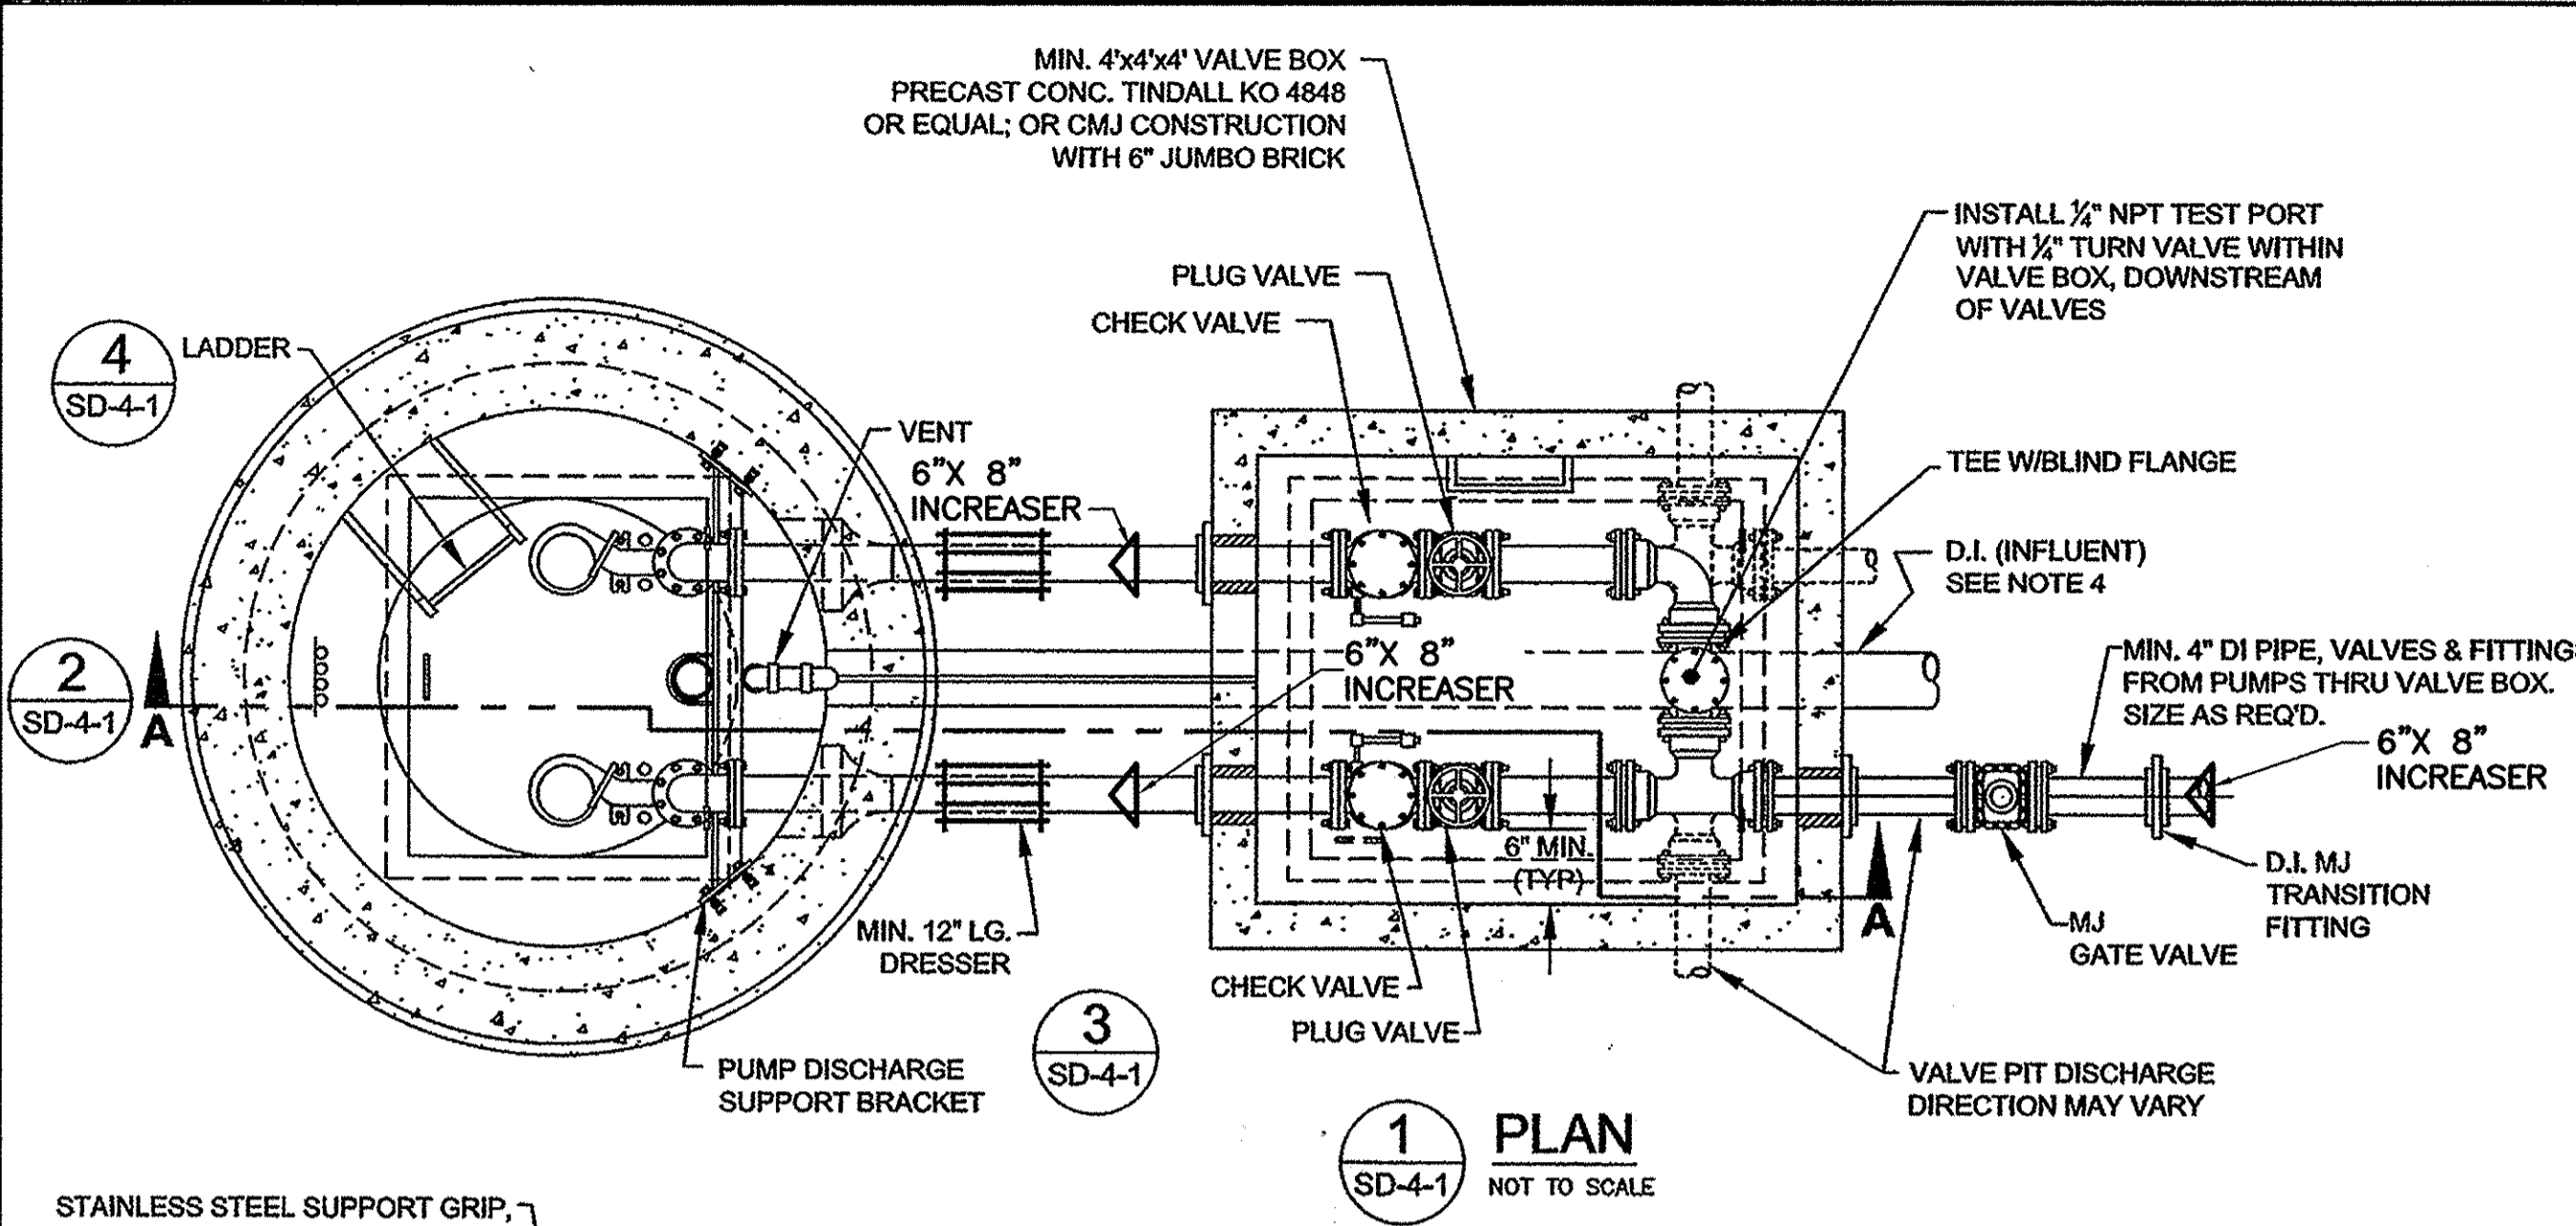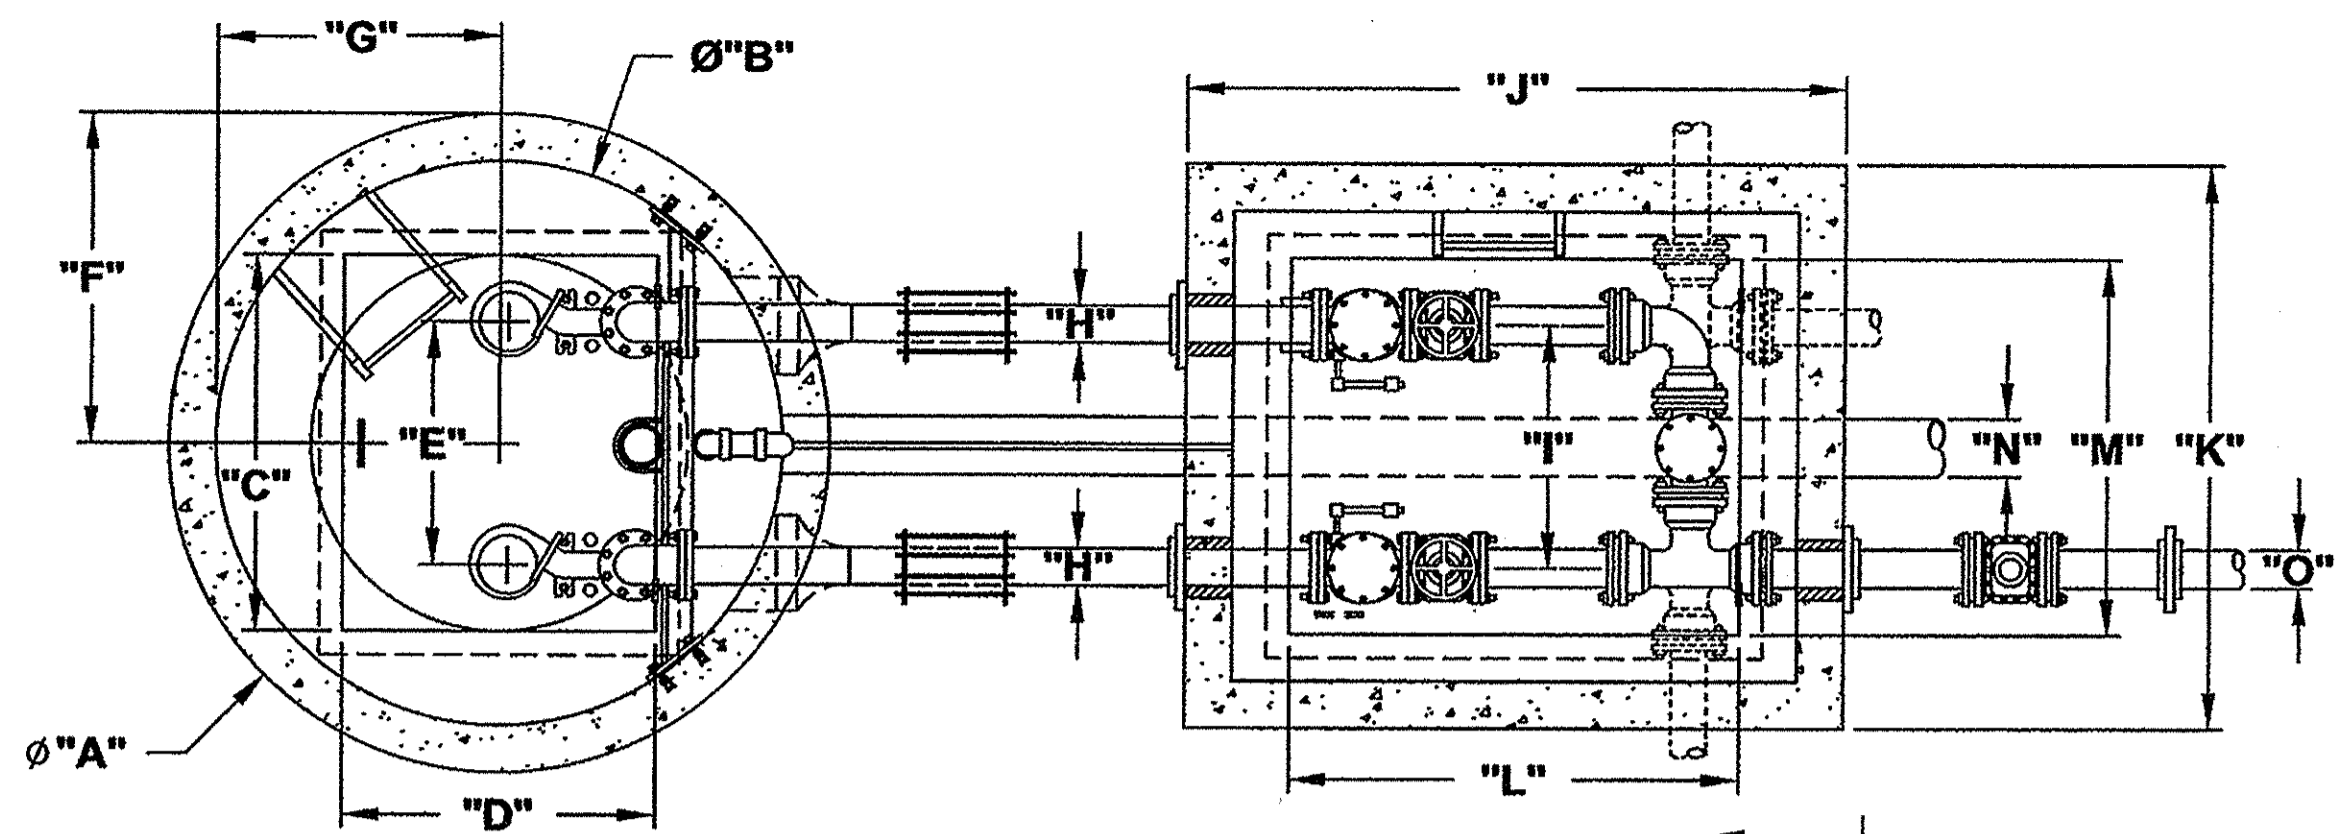


- NOTES:**
- UNLESS OTHERWISE SPECIFIED, ALL METAL WET WELL COMPONENTS, HARDWARE, AND FASTENERS, SHALL BE CAST IRON, DUCTILE IRON, OR 316 STAINLESS STEEL OR BETTER.
  - UNLESS OTHERWISE SPECIFIED, ALL CONCRETE FASTENERS TO BE 316 STAINLESS STEEL WEDGE ANCHORS (TYP).
  - CONCRETE FILLET IN BOTTOM OF WET WELL TO START 10" FROM THE ULTIMATE PUMP SIZE AND BASE AT 45° (TYP) ALL AROUND.
  - INFLUENT TO ENTER WET WELL CENTERED BETWEEN AND PARALLEL TO PUMP DISCHARGE PIPES. PROVIDE ONE 18" JOINT DIP AT WET WELL.
  - ONE PIECE SCHD. 40, 316 STAINLESS STEEL GUIDE RAILS. DIAMETER PER MANUFACTURERS RECOMMENDATIONS. TWO PIECE RAILS WITH INTERMEDIATE (MID 1/2) SUPPORT, FOR LENGTHS GREATER THAN 18 FEET.
  - PUMP REMOVABLE CHAIN AND RELATED LIFTING HARDWARE TO BE 3/8" MIN. 316-L STAINLESS STEEL 2000 LB MIN. WORKLOAD LIMIT. LENGTH TO EXTEND 4" ABOVE HATCH.
  - PUMP DISCHARGE SUPPORT BRACKET FOR DUCTILE IRON, OVER 10" MIN. ONE REQD. MIDWAY.
  - ACCESS HATCHES SHALL BE PAD LOCKABLE FRAME & COVER, WITH 1/2" ALUMINUM PLATE AND 1/2" THICK x 3" WIDE STAINLESS STEEL HINGES MIN. AND POSITIVE LOCKING DOOR RESTRAINT. HINGE ON DISCHARGE SIDE OF WET WELL AND VALVE BOX, (HALLIDAY PROD. OR EQUAL, SIZE AS REQD).
  - PLUG VALVES TO BE DEZURIK (FIG. 118) ECCENTRIC, CAST IRON BODY AWWA C504 WITH 4" HAND WHEEL & NON RISING STEM. SWING CHECK VALVES TO BE MUELLER IRON BODY, BRONZE MOUNTED AWWA C508 WITH OUTSIDE SPRING & LEVER. ELEVATION OF TOP OF WET WELL AND ELEC. CONDUITS SHALL BE 2.0 FEET ABOVE THE 100 YEAR FLOOD ELEVATION.
  - CONCRETE PAD (36" MINIMUM WIDTH W/45° CHAMFER) AROUND OUTSIDE DIAMETER OF WET WELL.

- SITE LAYOUT NOTES:**
- ALL STRUCTURES TO BE PARALLEL AND PERPENDICULAR TO EACH OTHER.
  - PROVIDE 3" MIN. SEPARATION BETWEEN ALL STRUCTURES, AND TO FENCE.
  - ALL TOP OF SLAB ELEV. TO BE UNIFORM.
  - AREA INSIDE FENCE TO HAVE 4" #57 M WASHED STONE.
  - UTILITY METER BASE TO BE LOCATED OUTSIDE OF FENCE.
  - ACCESS DRIVE AND TURN AROUND (WHERE REQD.) TO BE 6' ABC, MINIMUM.
  - FENCE GATE MUST ALLOW DIRECT IN LINE ACCESS TO WET WELL.

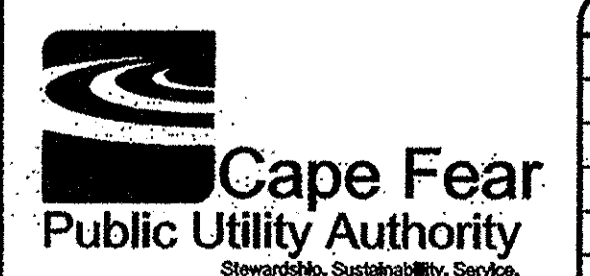

REV.	DESCRIPTION	DATE:
A	CFPUA Revisions	05/14/08
B	Engineering Revisions	02/18/09
C	CFPUA Revisions	03/11/09
D	CFPUA Revisions	06/22/09

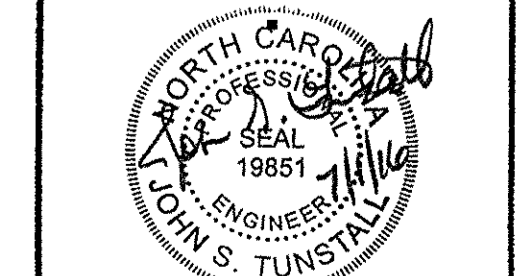


**PUMP STATION / SITE PLAN  
STANDARD DETAILS**

**CAPE FEAR  
PUBLIC UTILITY AUTHORITY  
PUMP STATION / SITE PLAN STANDARD DETAILS  
SD-4**

CAPE FEAR PUBLIC UTILITY AUTHORITY  
235 GOVERNMENT CENTER DRIVE  
WILMINGTON, NC 28403  
OFFICE: (910)332-6560

DATE: 6/28/16  
SCALE: N/A  
DRAWN BY:  
CHECKED BY:  
PROJECT NO.: 15048  
SHEET NO.: PR5

THESE DETAILS ARE A WORK PRODUCT OF CFPWA FOR WATER AND SEWER SYSTEM DESIGN AND CONSTRUCTION AND HAVE BEEN REVIEWED AND APPROVED FOR CONTENT AND GENERAL CONFORMANCE WITH THE WATER AND SEWER DESIGN FOR THIS PROJECT.

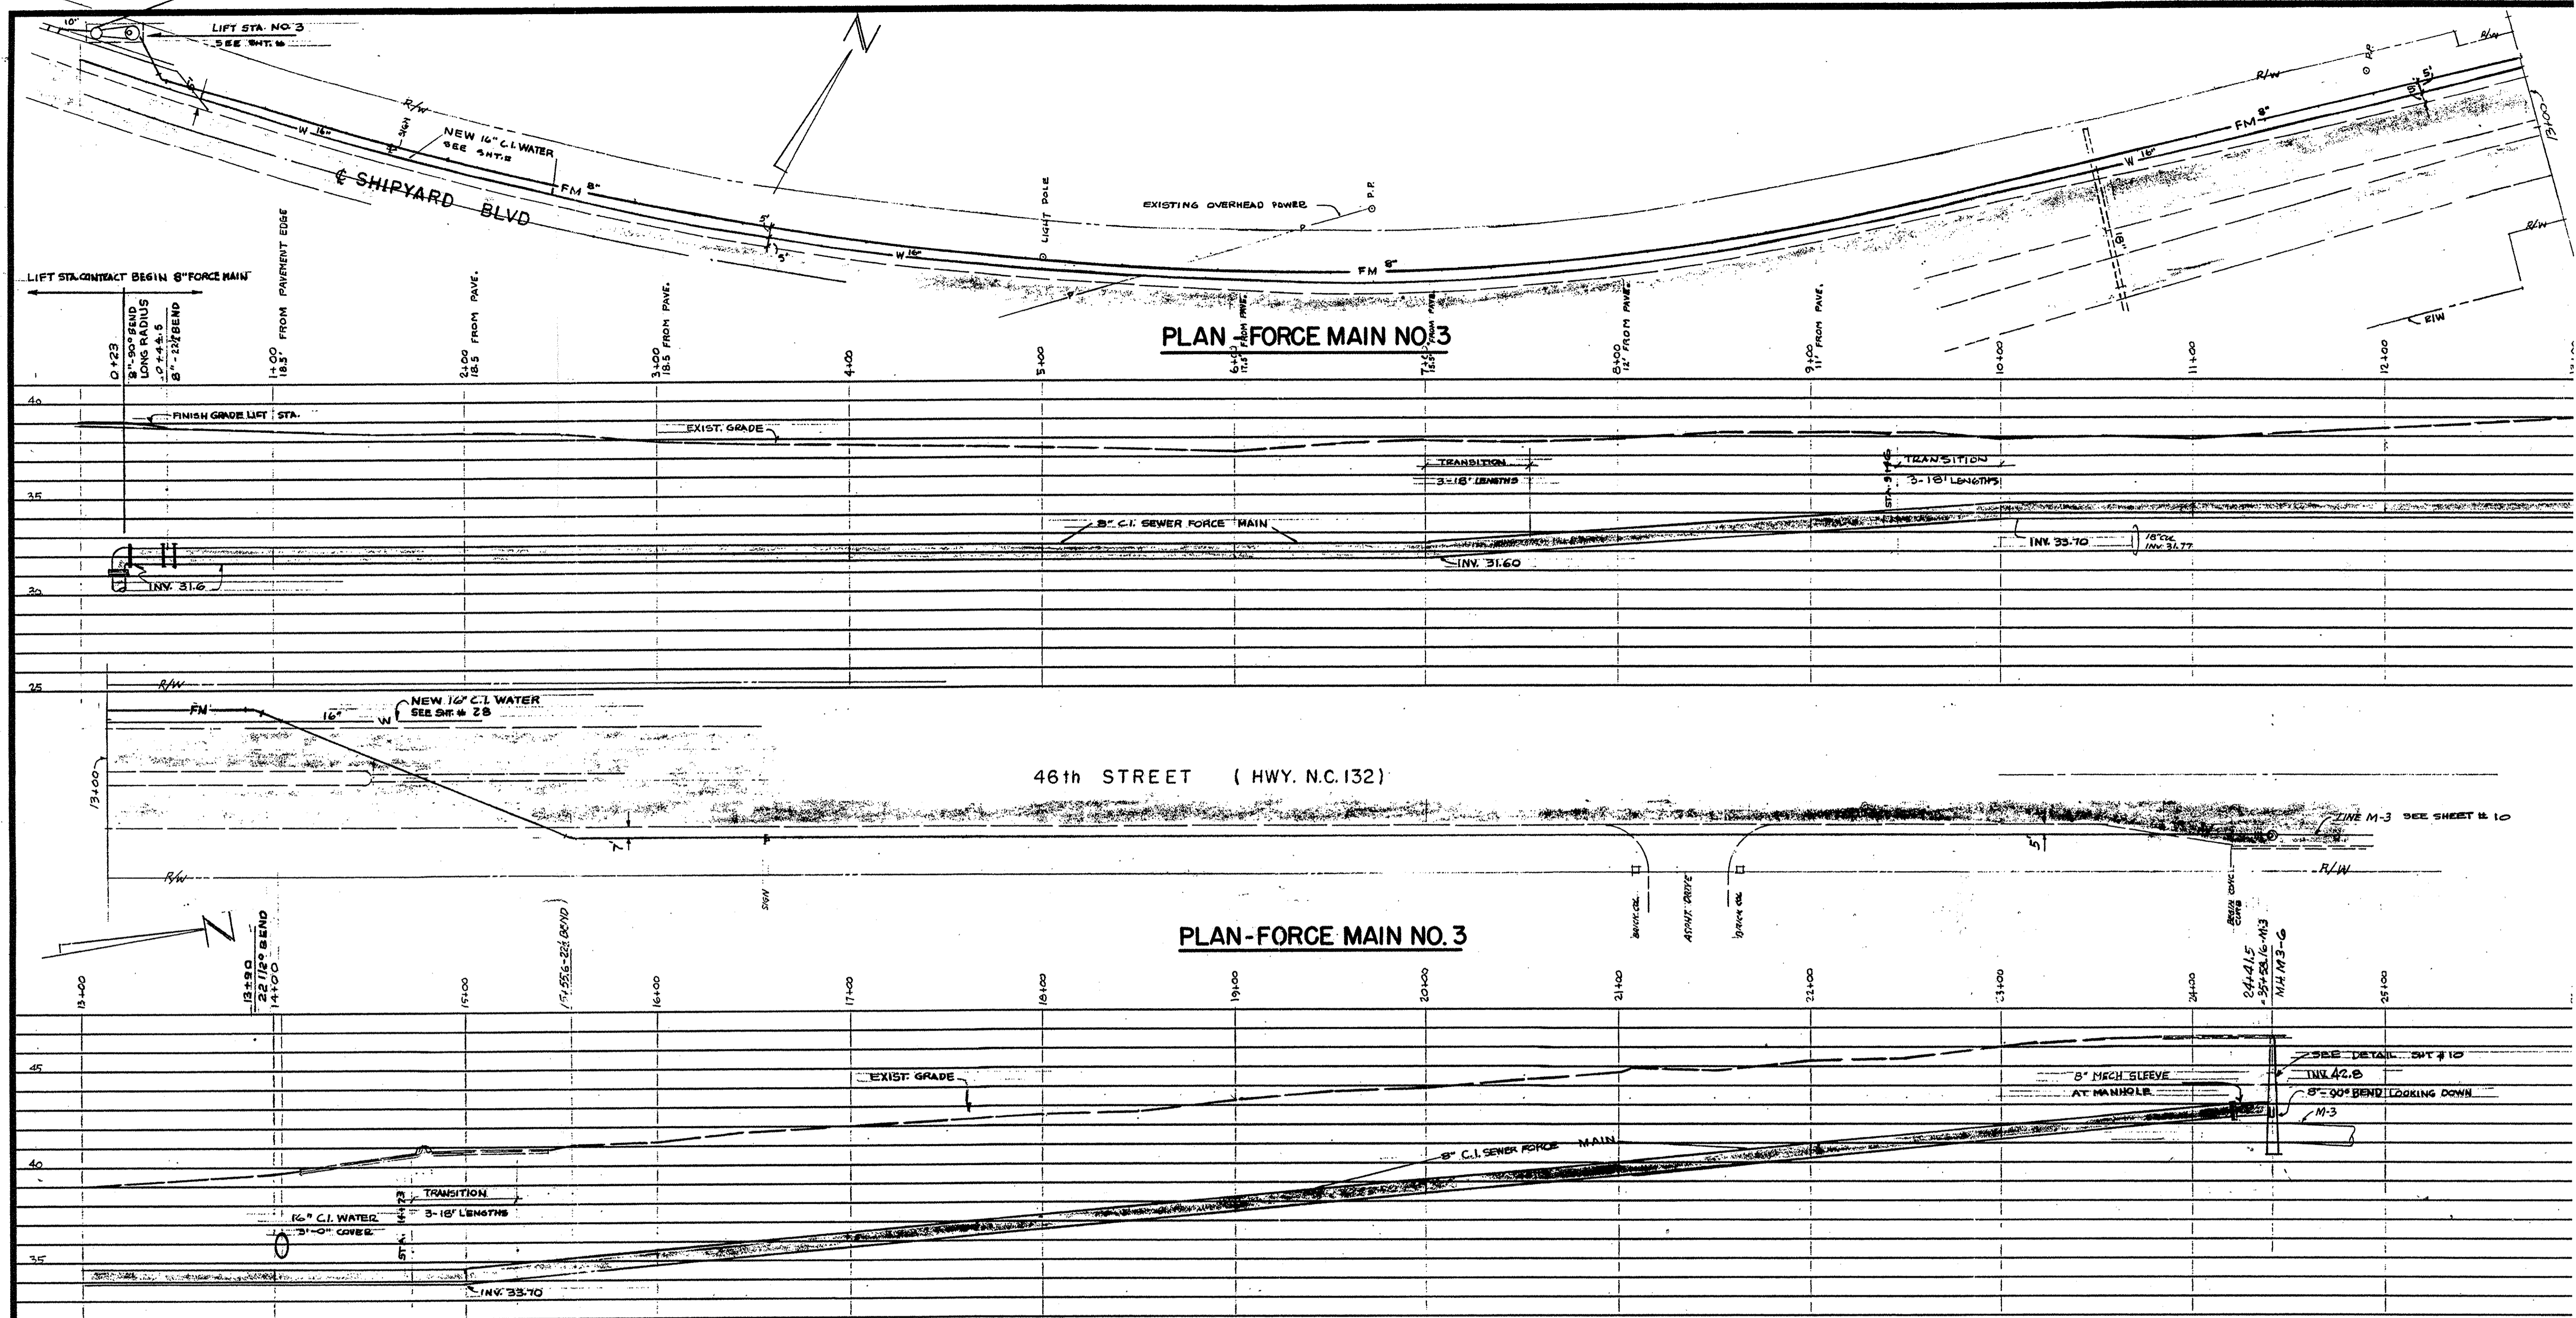

**PLAN FORCE MAIN NO 3**

**PLAN-FORCE MAIN NO. 3**















46th STREET (HWY. N.C. 132)

FOR LEGEND SEE SHET 22

SYMBOL	DATE	DESCRIPTION
REVISIONS		
<b>SANITARY SEWER &amp; WATER IMPROVE</b>		
<b>CITY OF WILMINGTON</b>		
NORTH CAROLINA		
<b>SANITARY SEWER EXTENSION:</b>		
<b>PLAN AND PROFILE</b>		
<b>FORCE MAIN # 3</b>		
<b>SHIPYARD BOULEVARD</b>		
<b>HENRY VON OESSEN &amp; ASSOCIA</b>		
<b>CONSULTING ENGINEERS</b>		
WILMINGTON, N. C.		

<p>RECORD DRAWINGS CONFORMS TO CONSTRUCTION RECORDS JUN 27 1967</p>		<p>DATE JULY 1 69</p>
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RECORD DRAWINGS  
CONFORMS TO  
CONSTRUCTION RECORDS  
JUN 27 1967

CONSTRUCTION NOTES  
1. REPAIR ALL EXISTING CURBS AND PAVEMENT TO MATCH CONTRACT SPECIFICATIONS MAINTAIN TO 2" ST. 2. TERMINATE 10" SERVICE FROM OUTSIDE WALL OF STA. 3. TERMINATE 5" CAST IRON FORCE MAIN 6" x 6" x 20' STATION ON 2" SERVICE POLE.

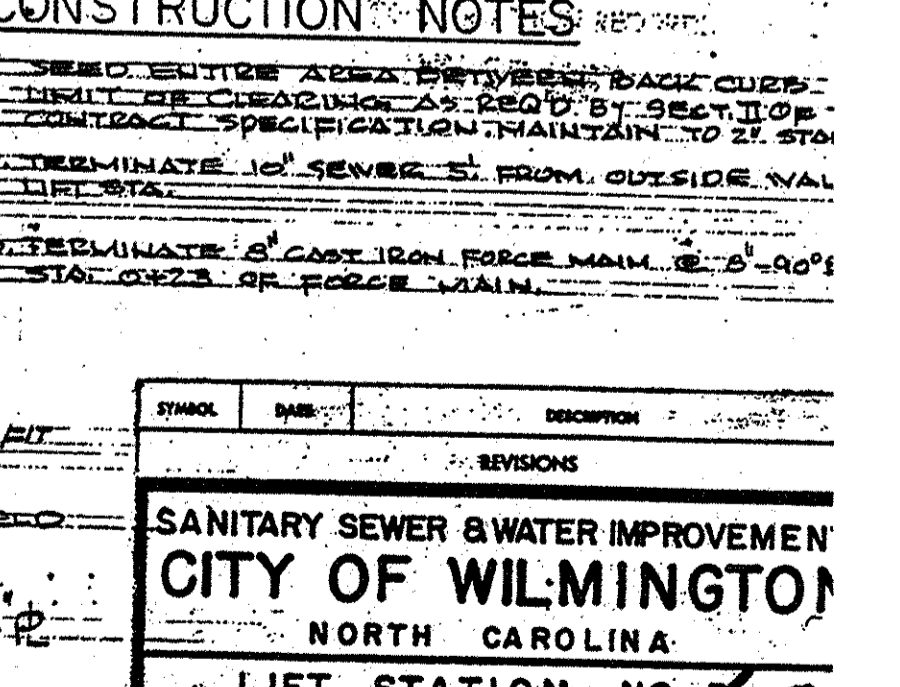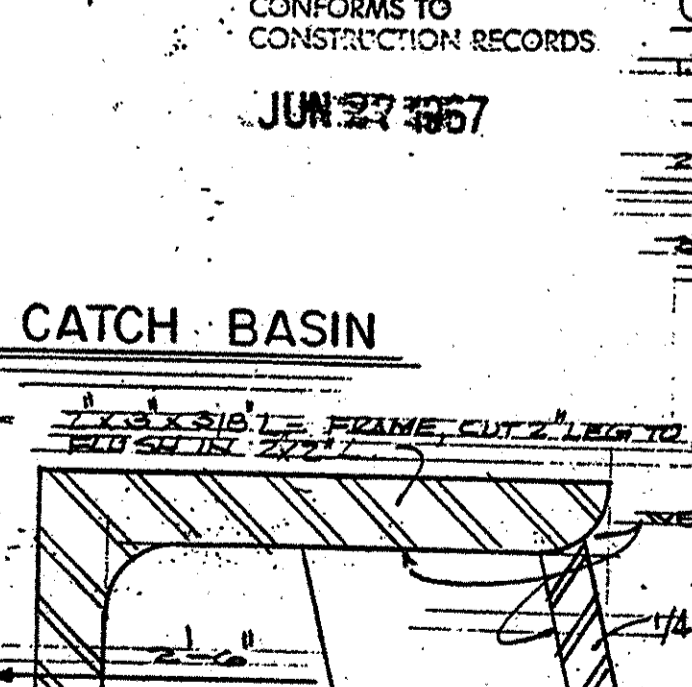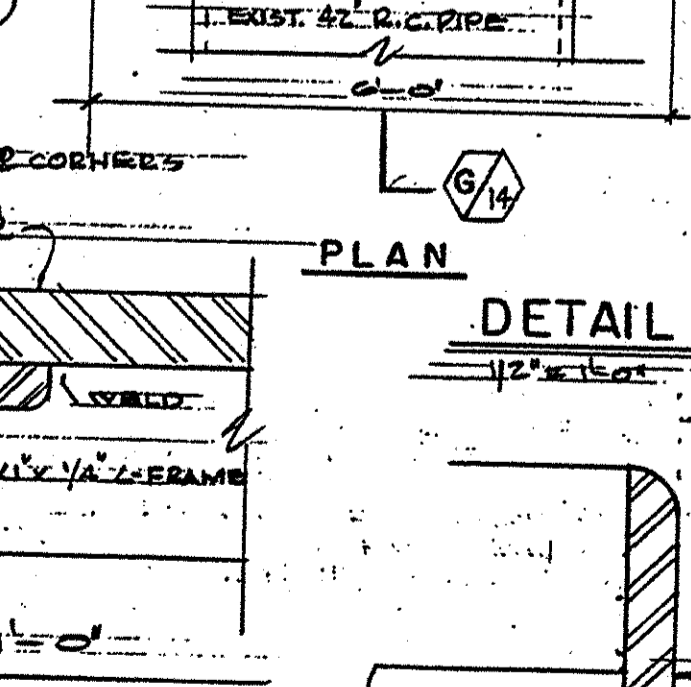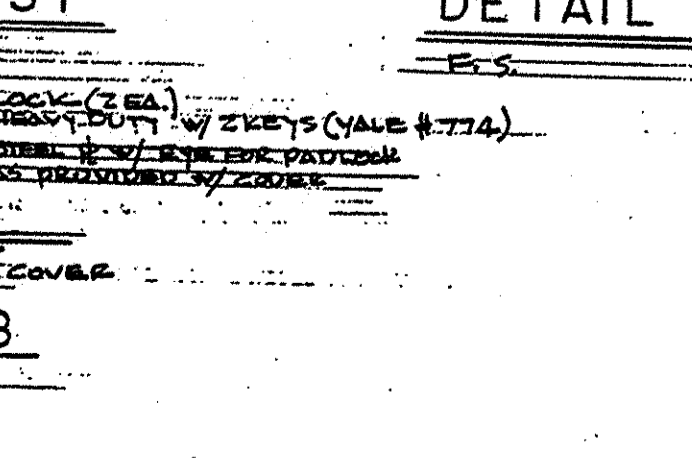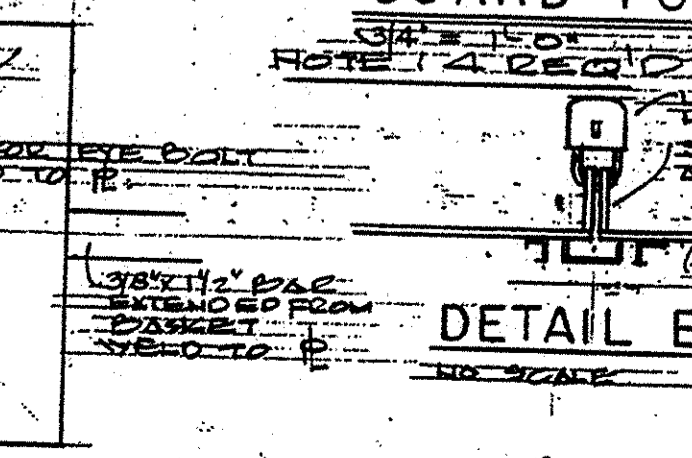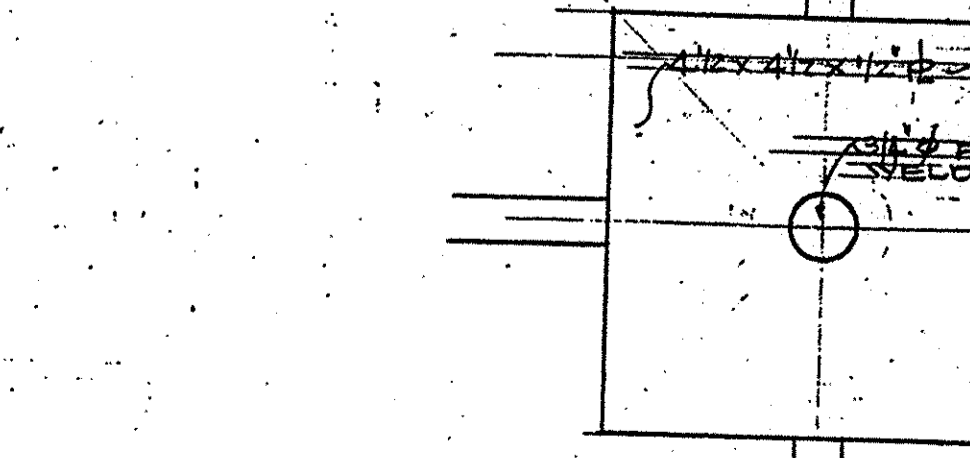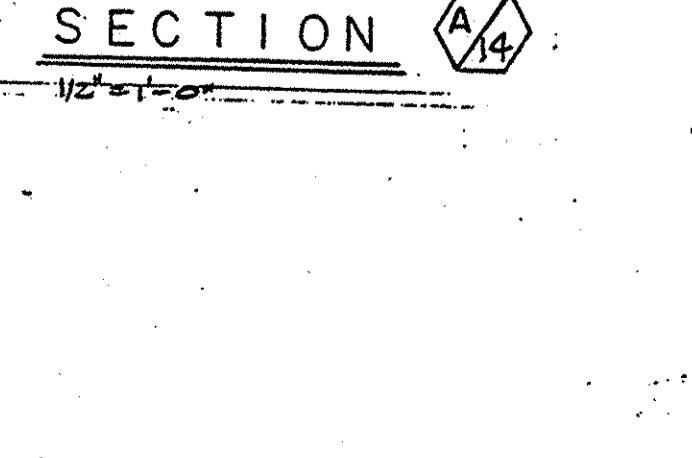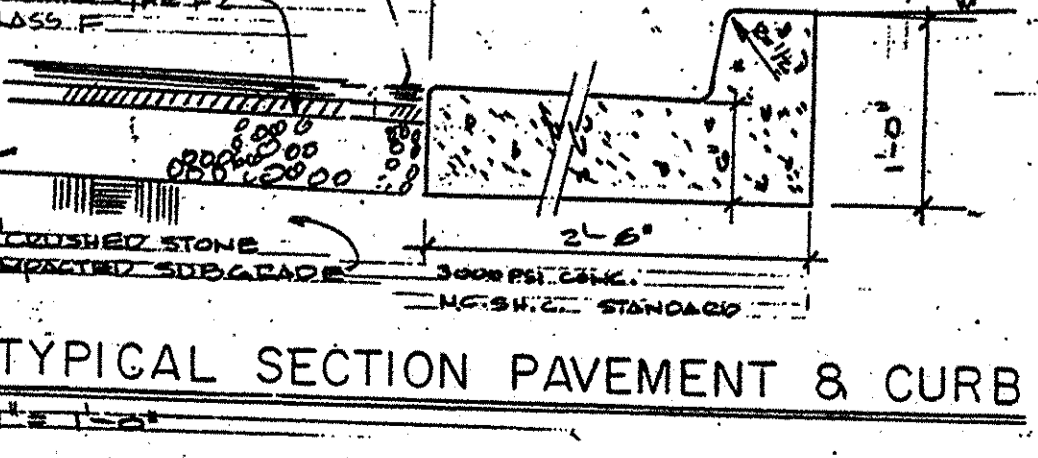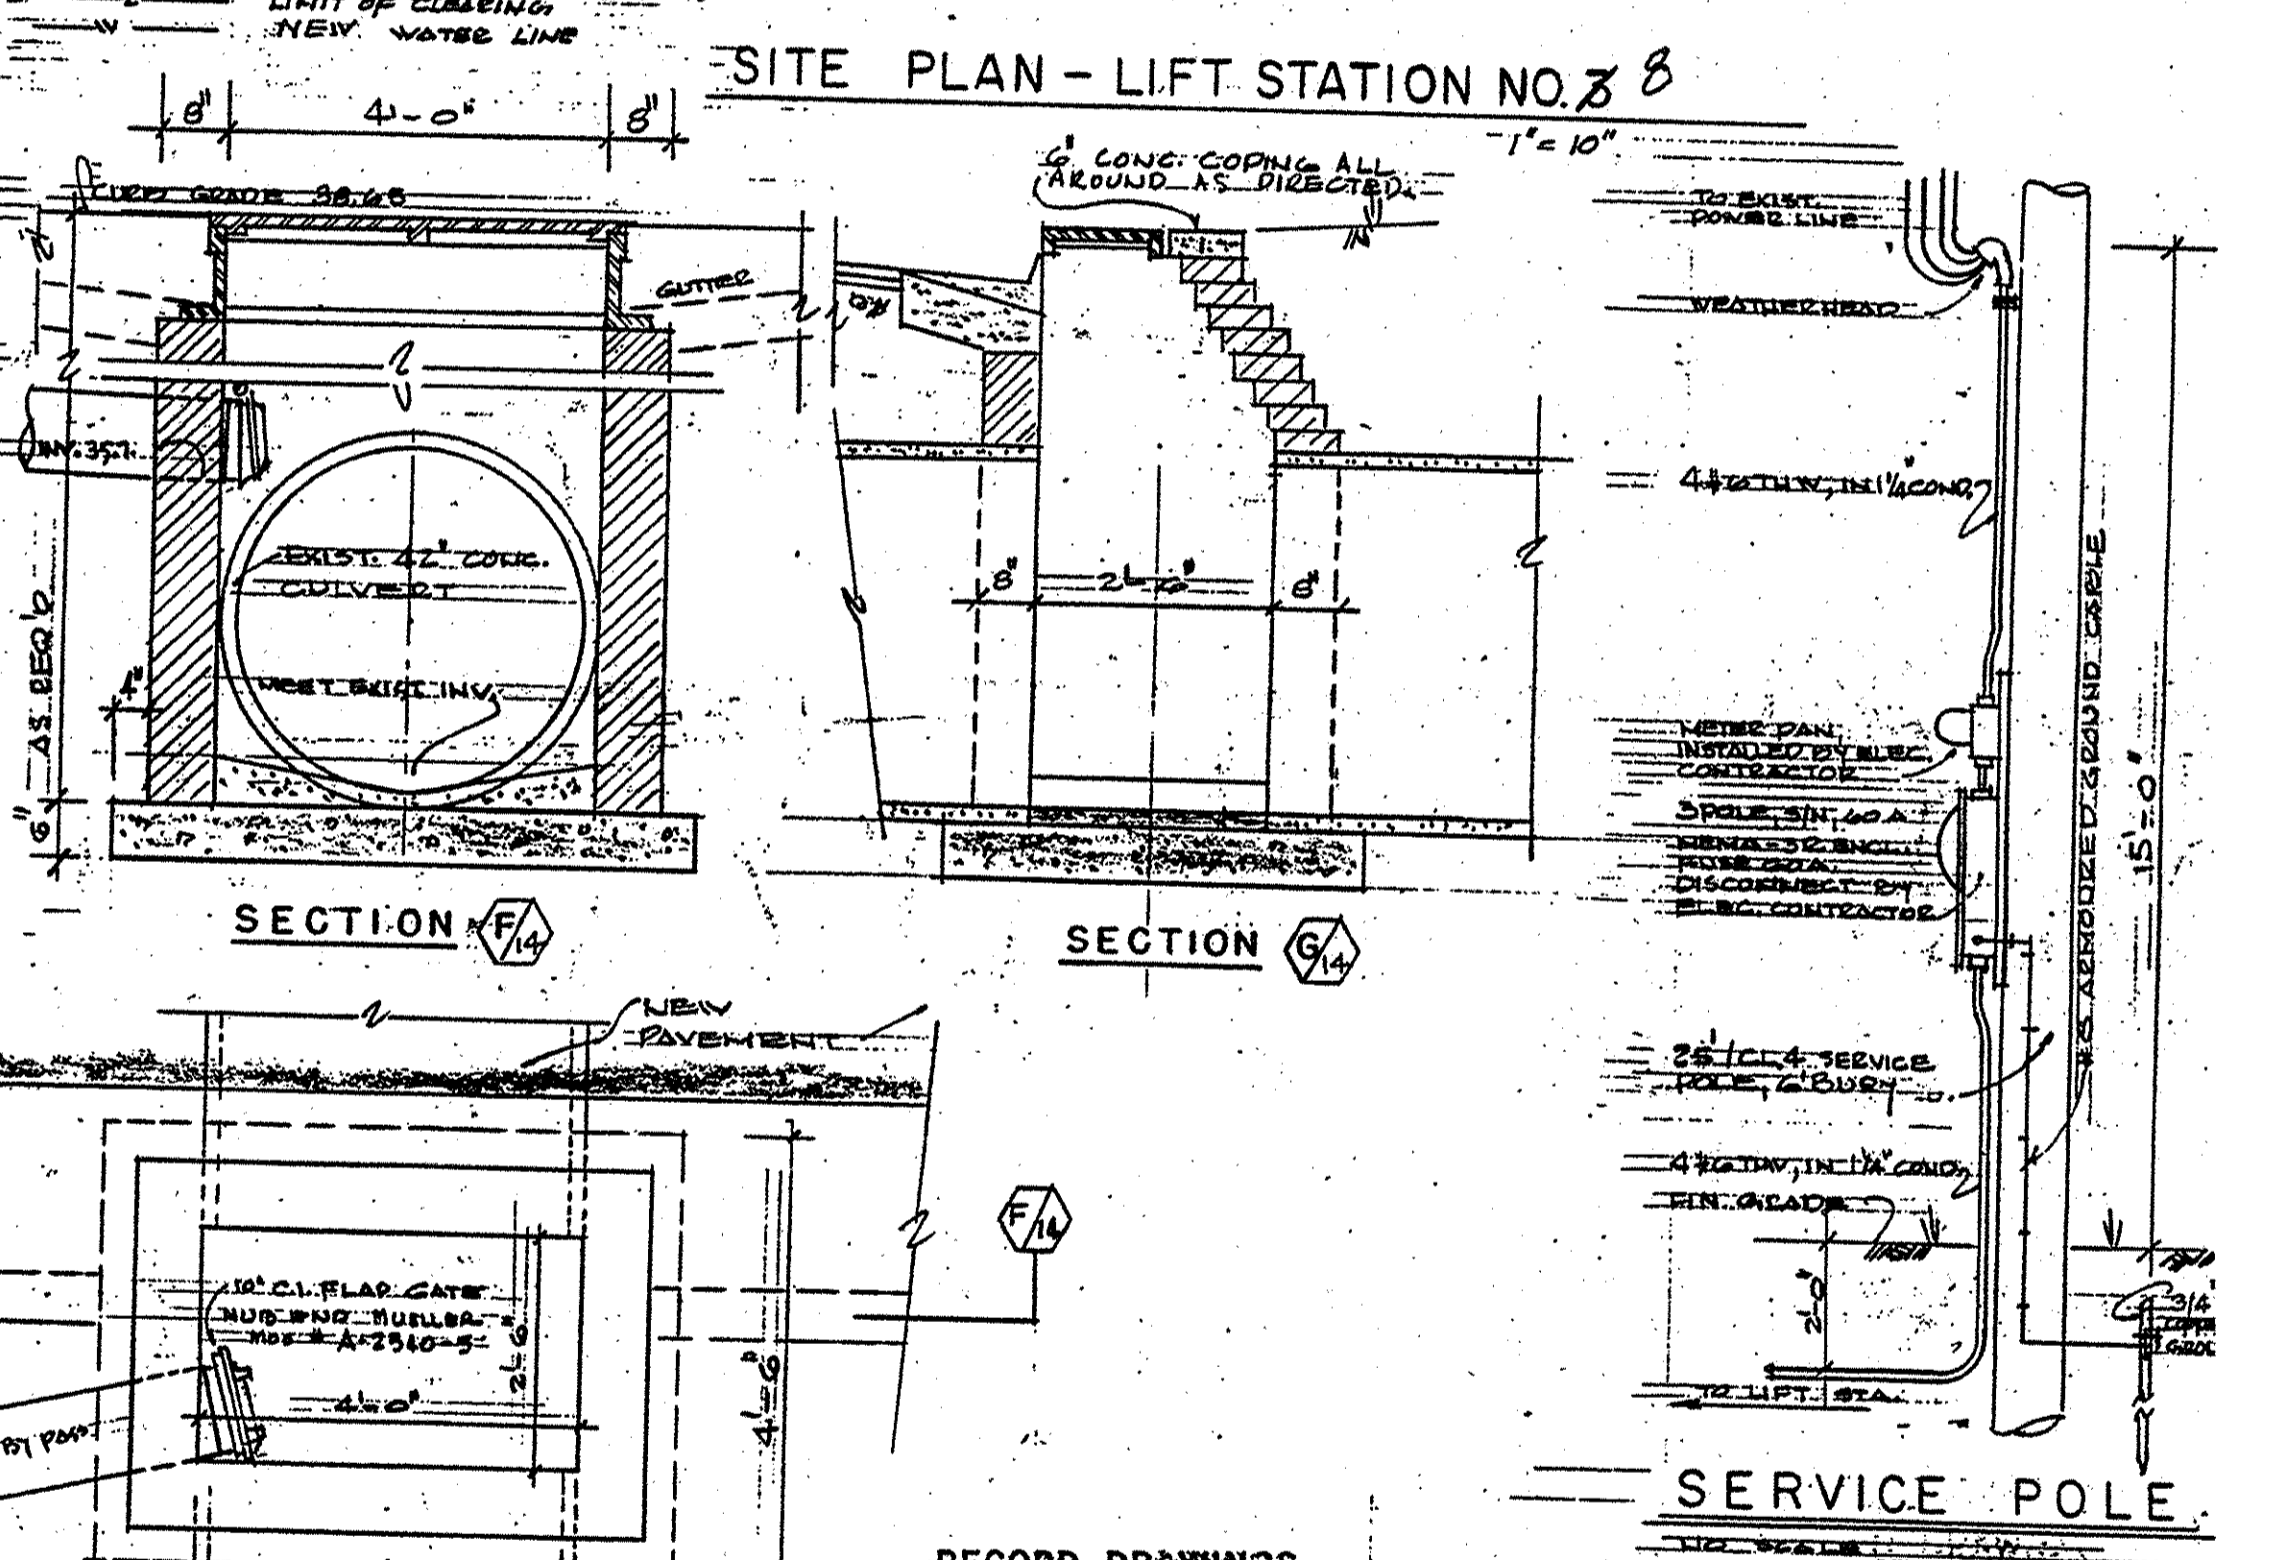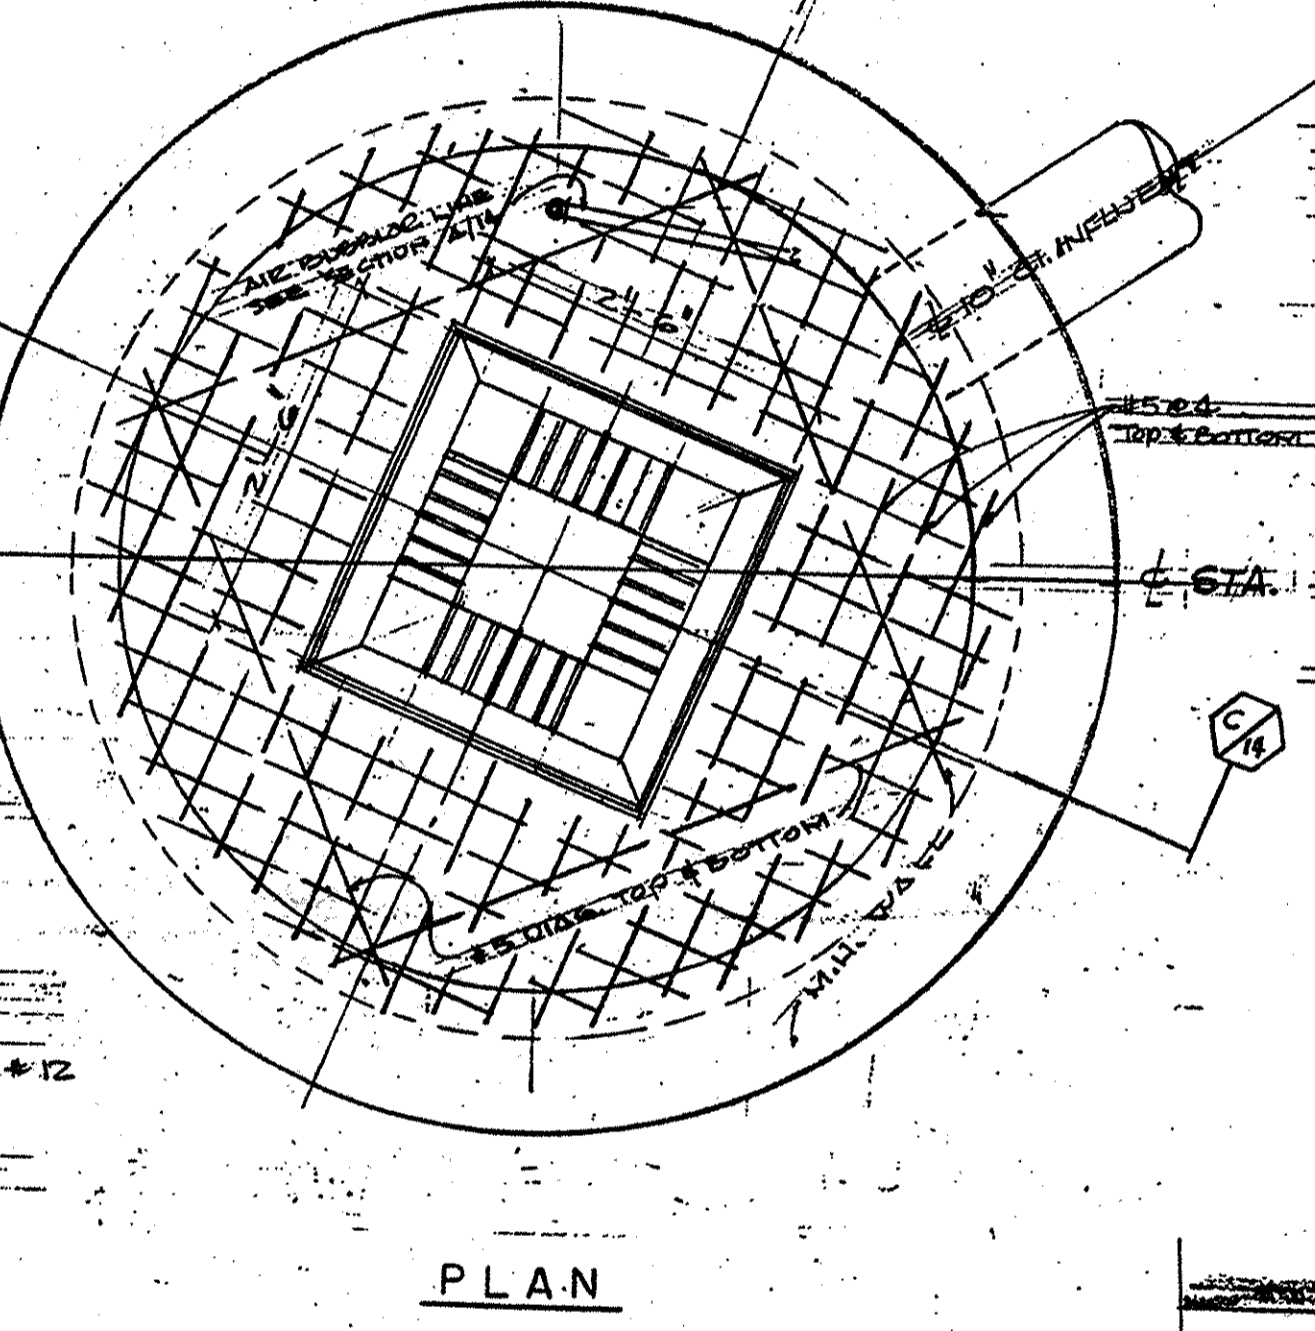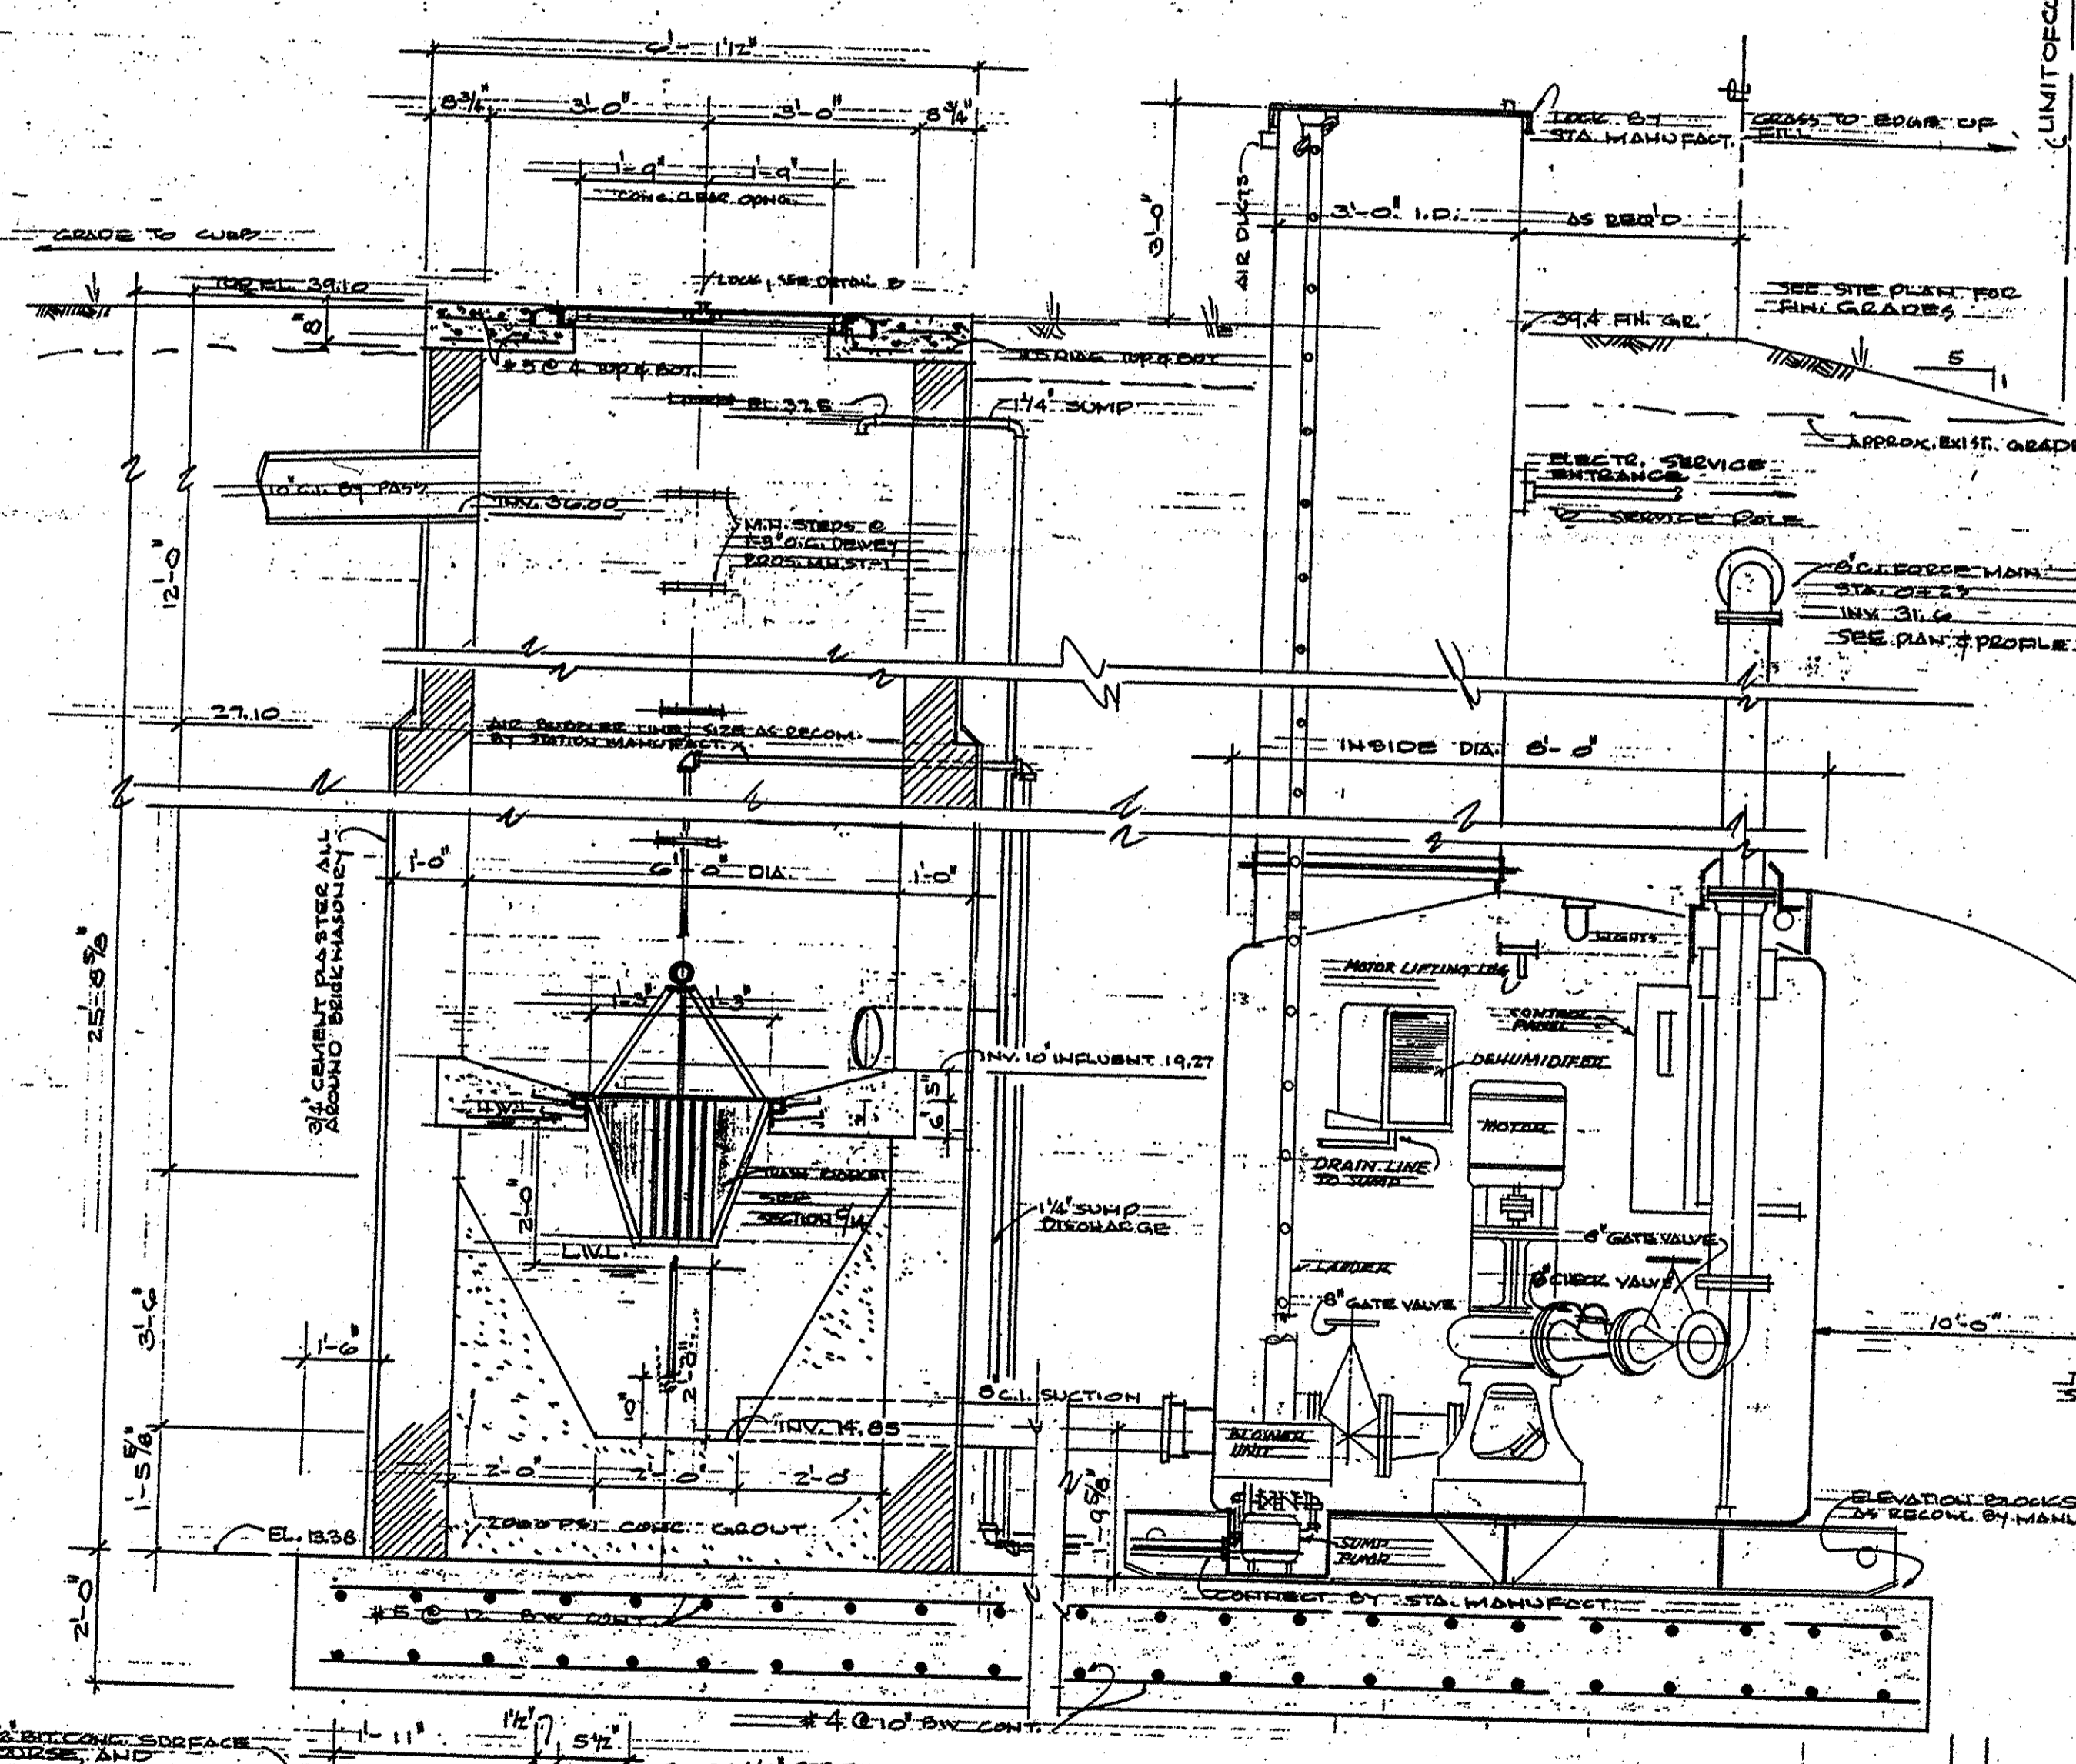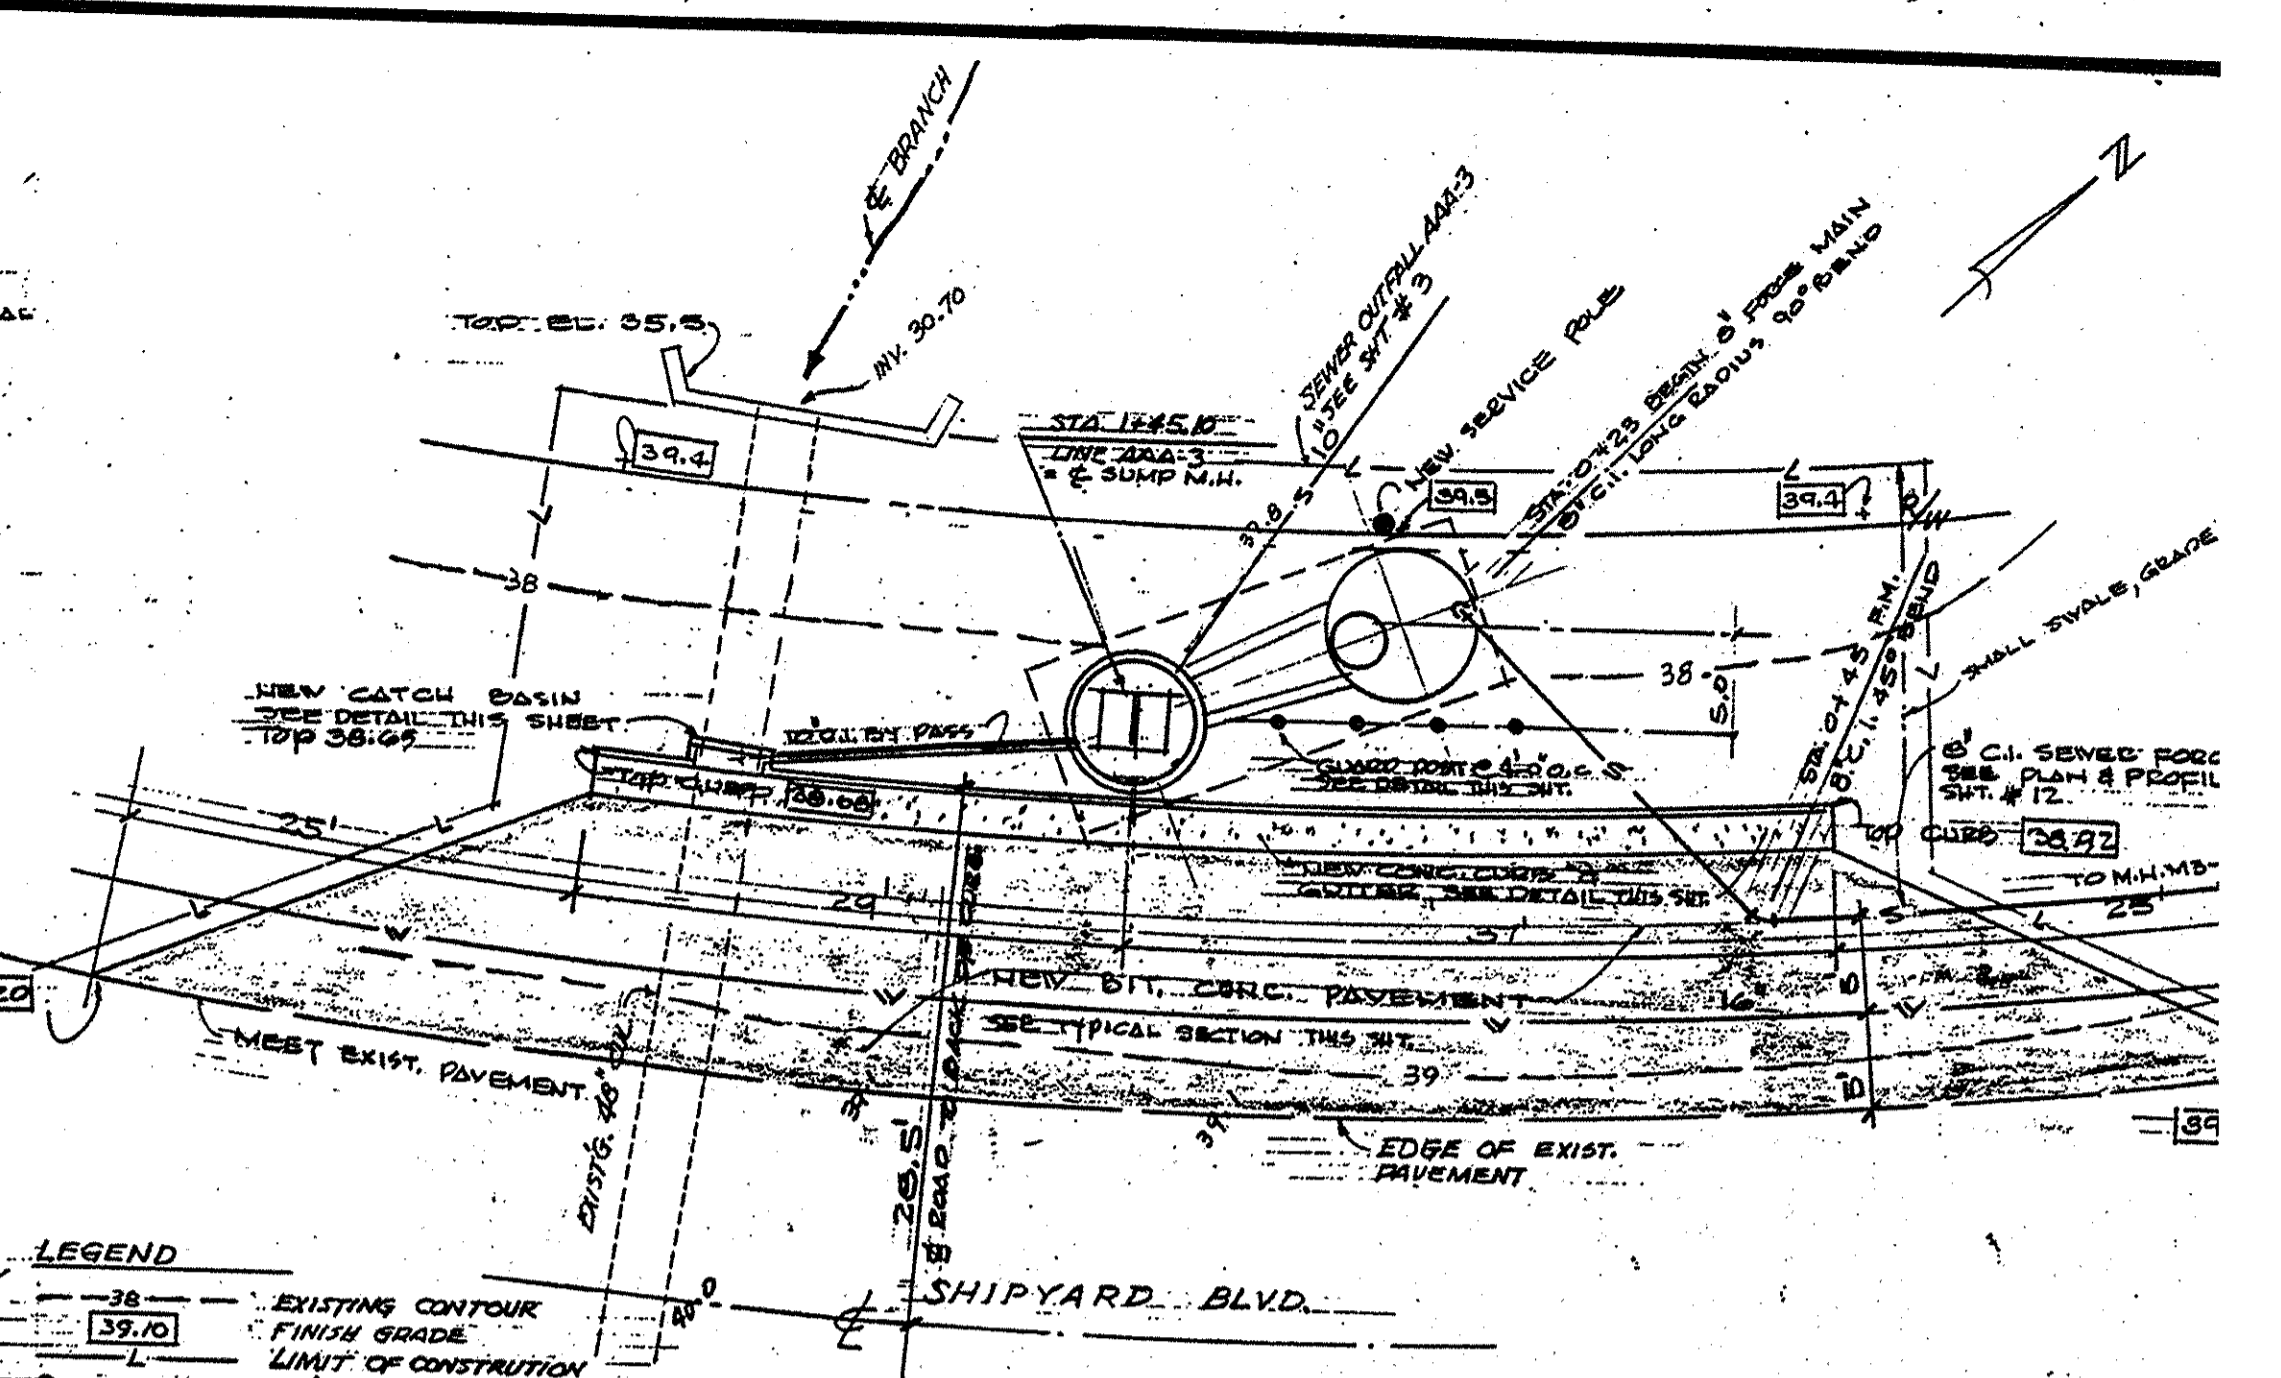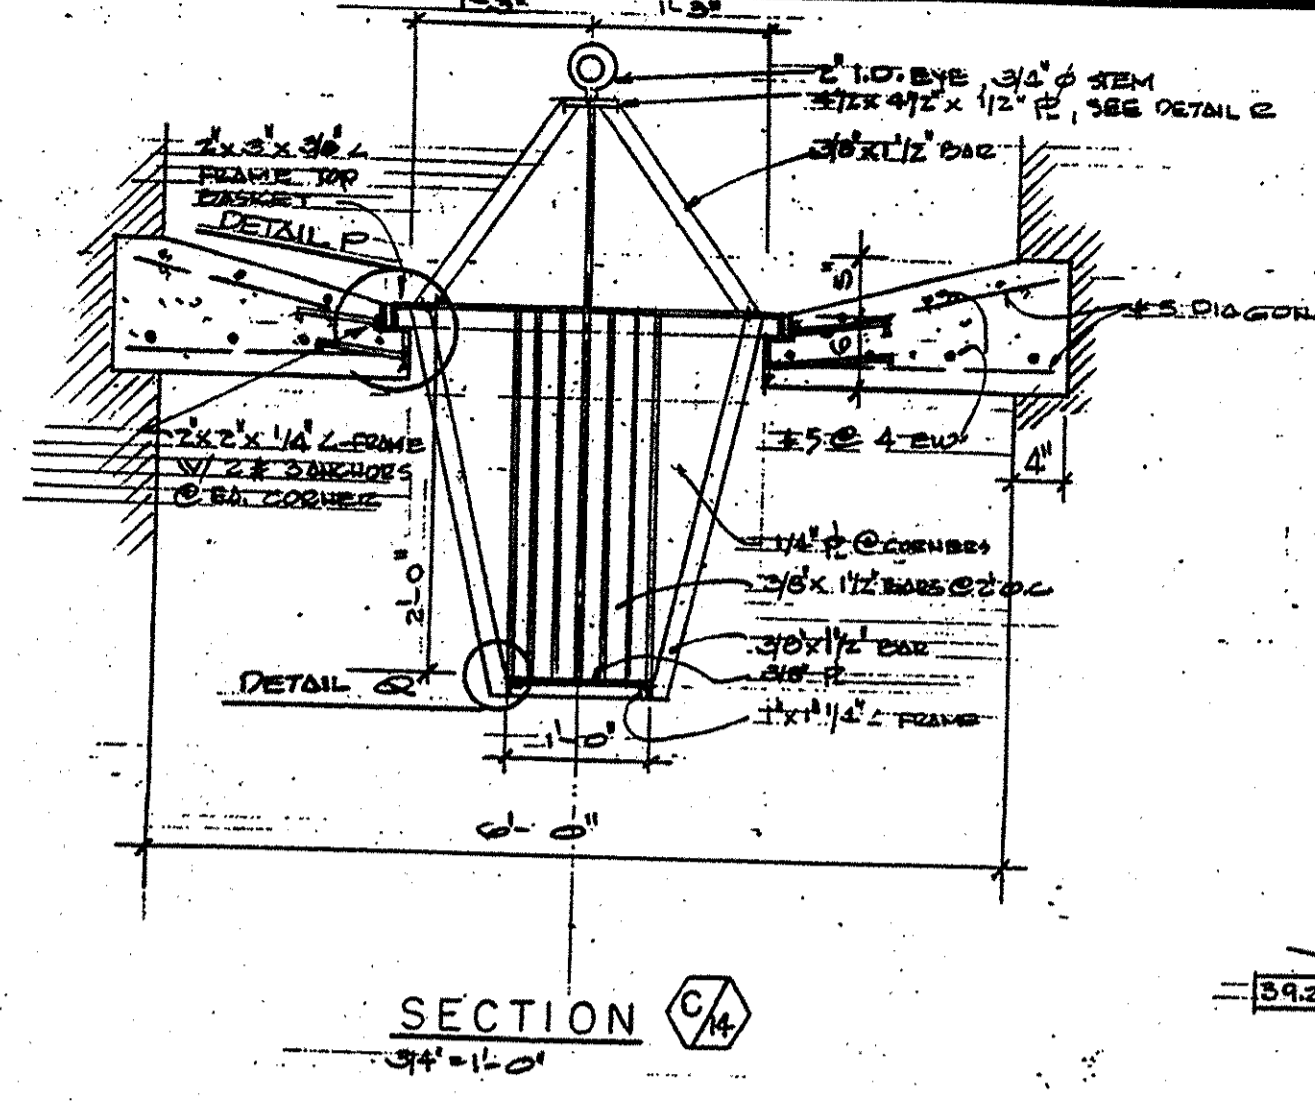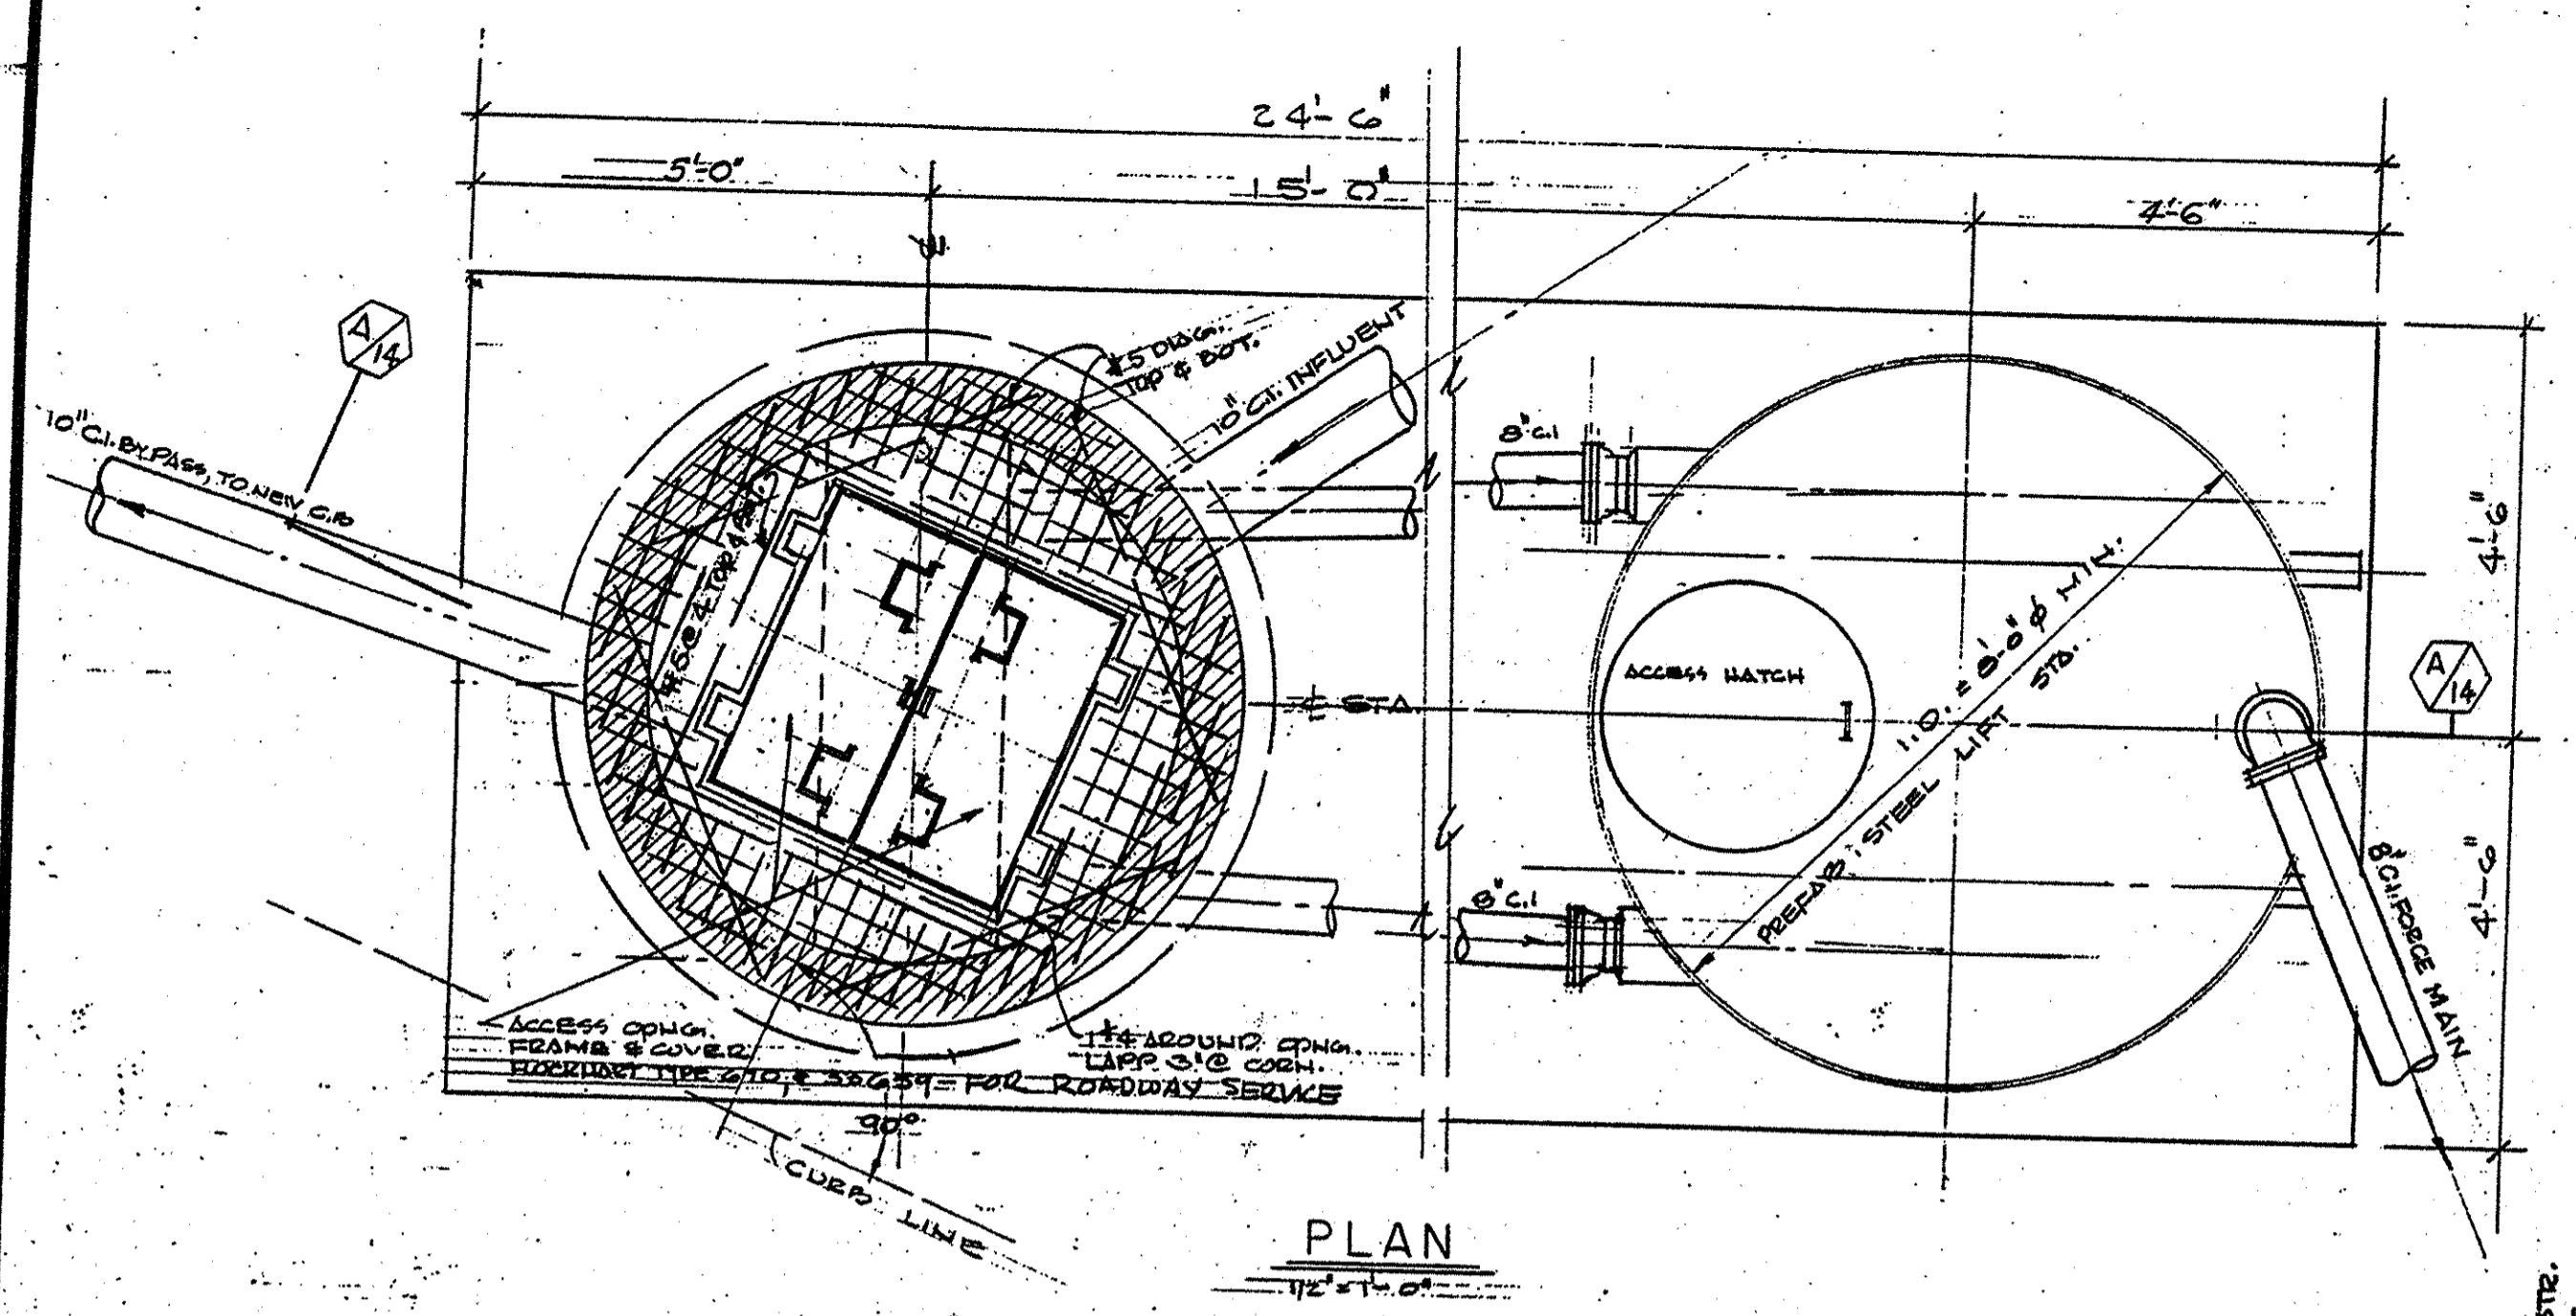
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1		ISSUED FOR PERMITS
2		ISSUED FOR CONSTRUCTION
3		ISSUED FOR RECORDS

**SANITARY SEWER & WATER IMPROVEMENT  
CITY OF WILMINGTON  
NORTH CAROLINA**


**LIFT STATION NO. 18**  
*Shipyard*  
SITE PLAN, SECTIONS AND DETAIL

**HENRY VON OSEN & ASSOCIATE  
CONSULTING ENGINEERS  
WILMINGTON, N. C.**


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SEAL  
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15048

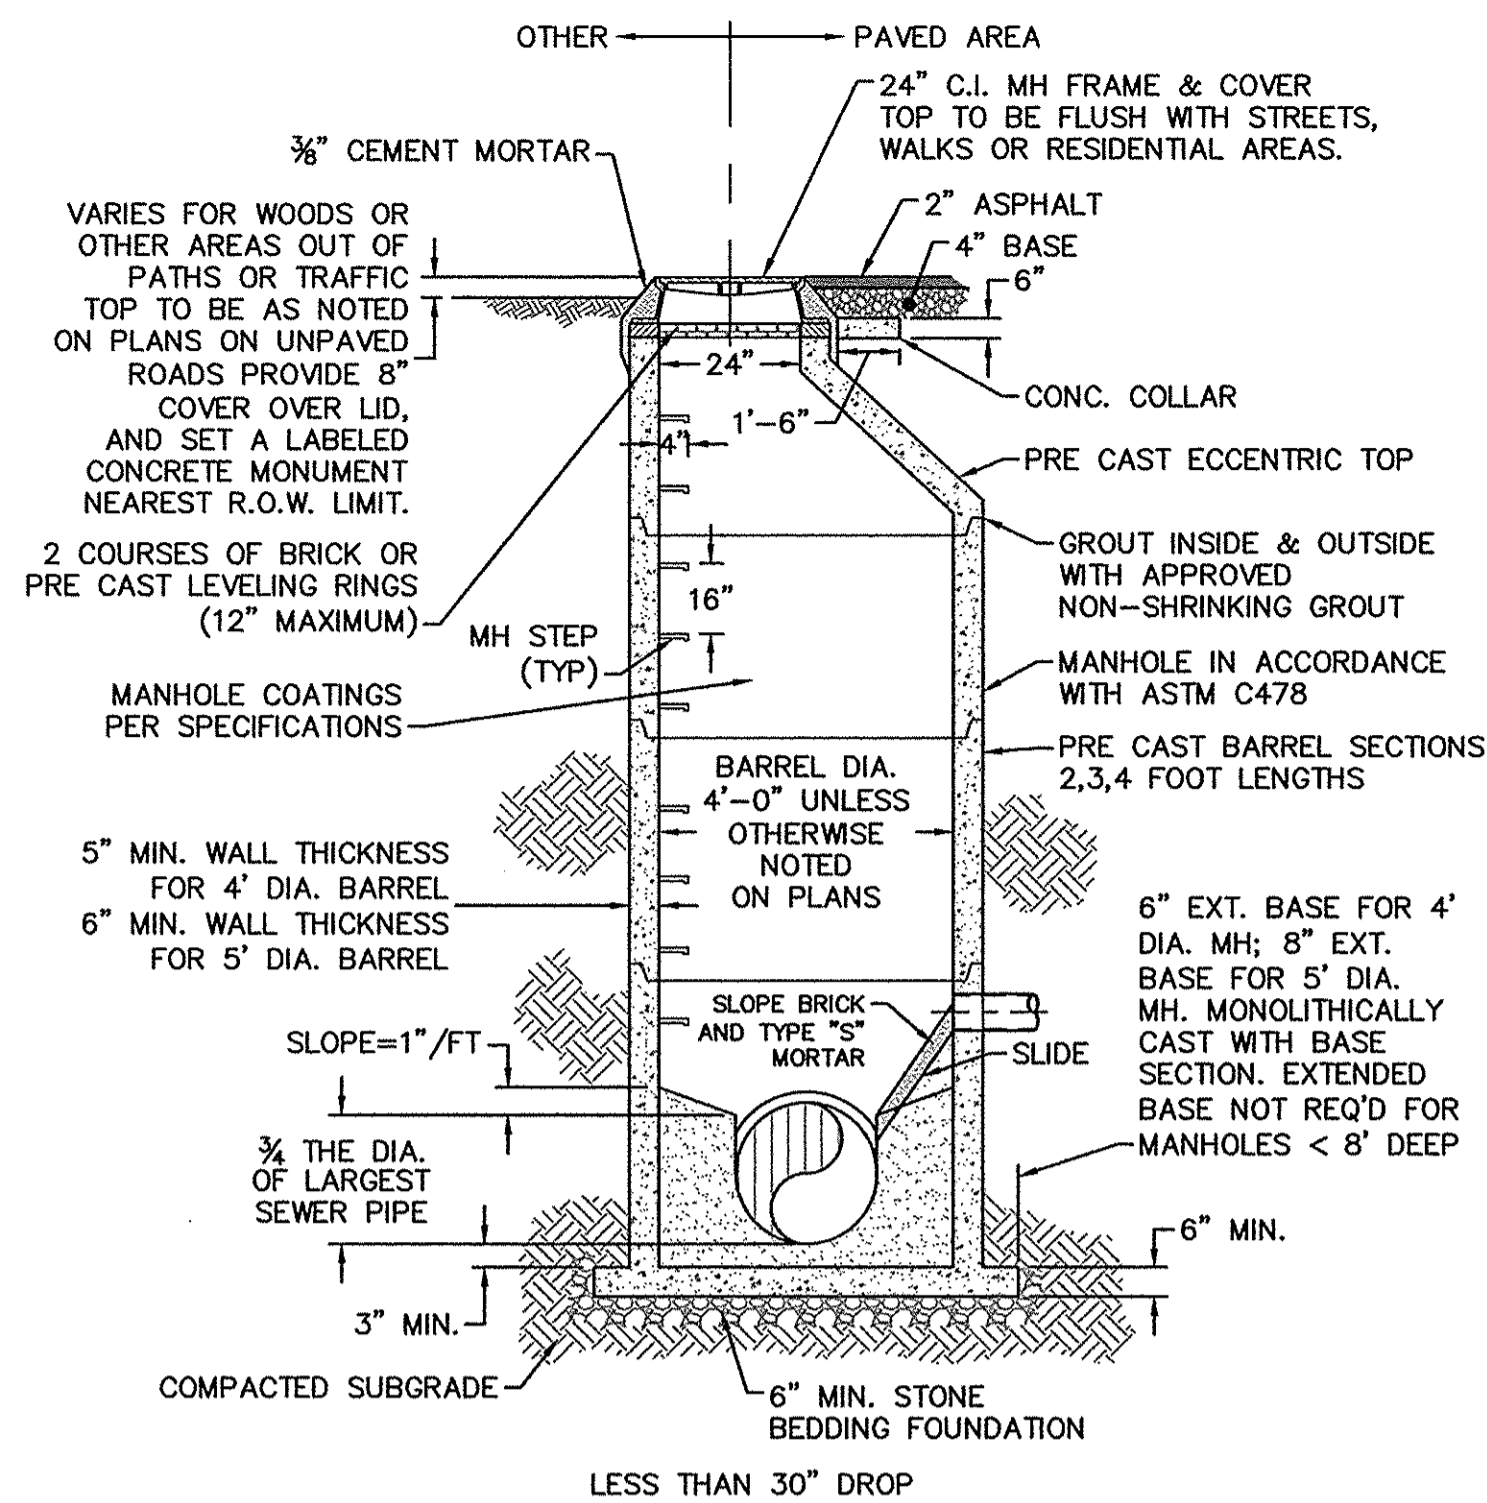


**SD-1 PRECAST CONCRETE OFFSET MANHOLE TYPICAL**  
NOT TO SCALE

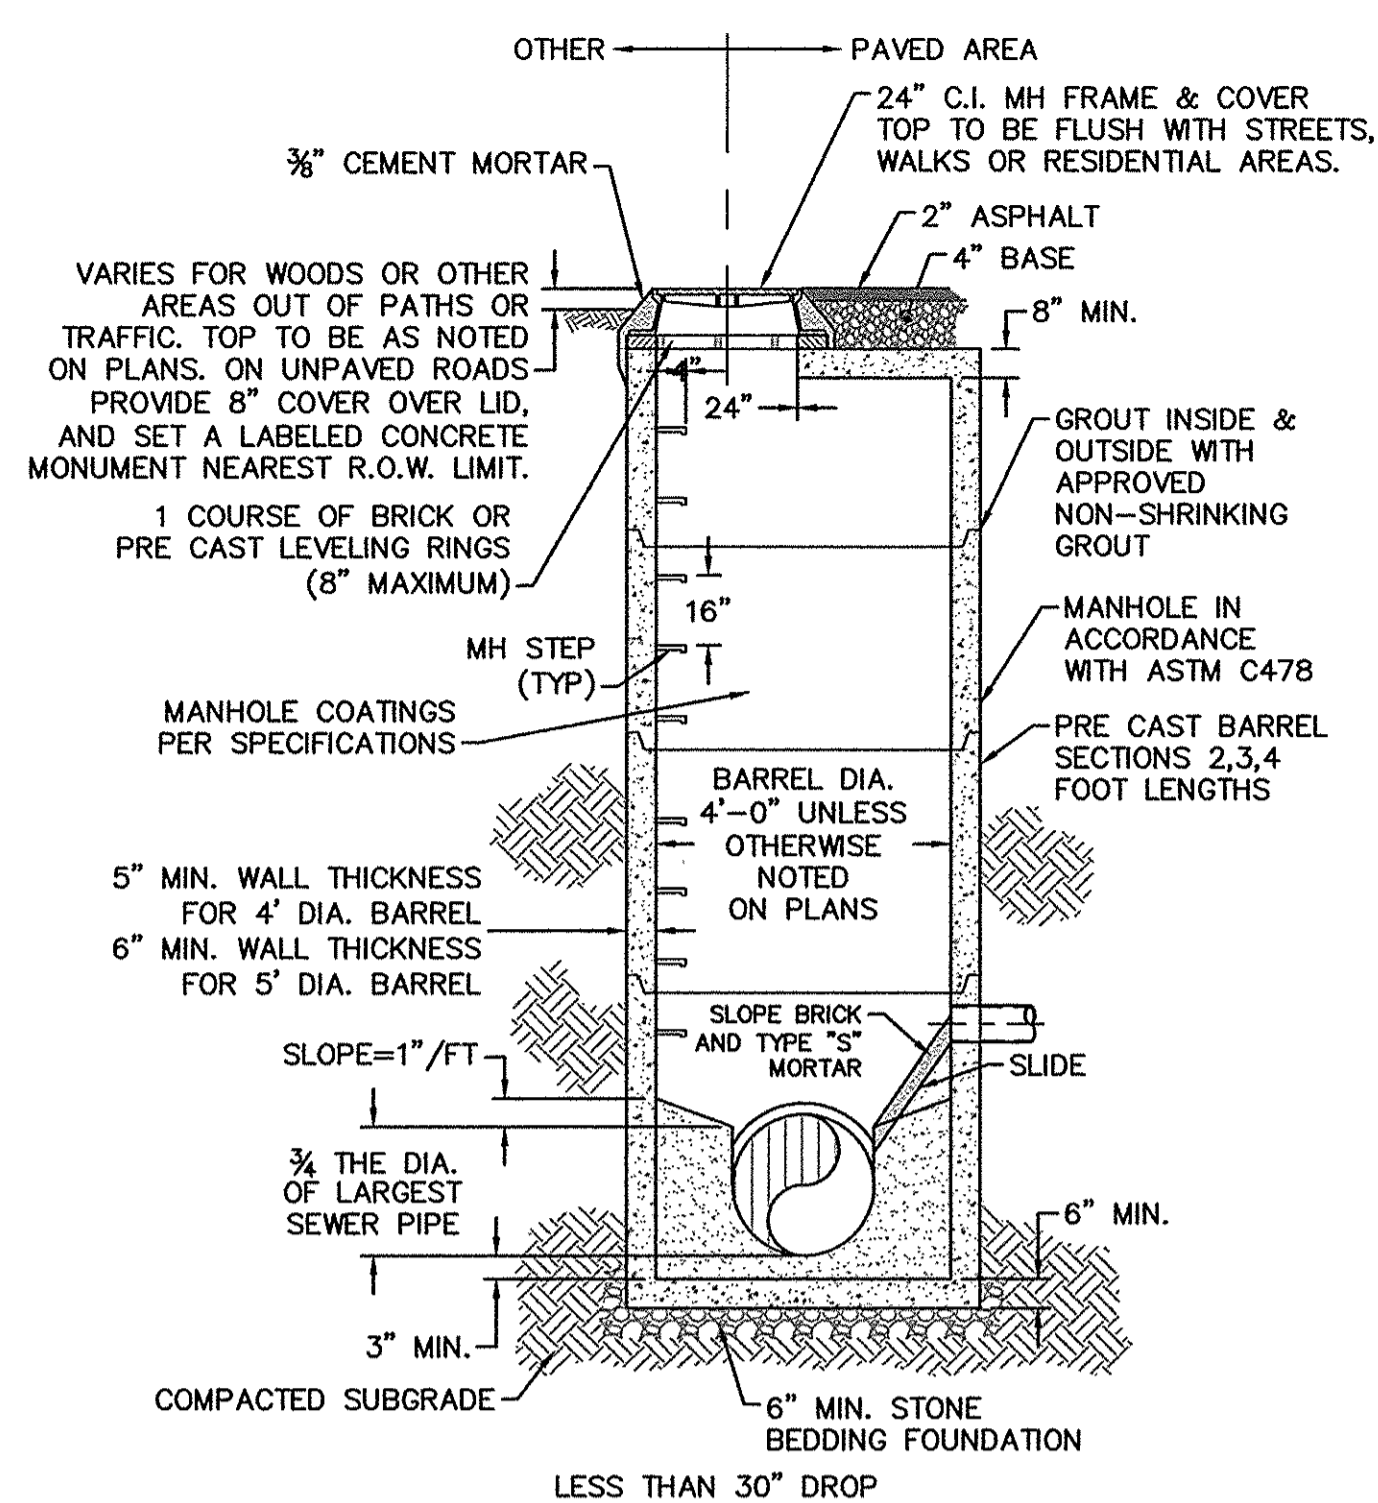


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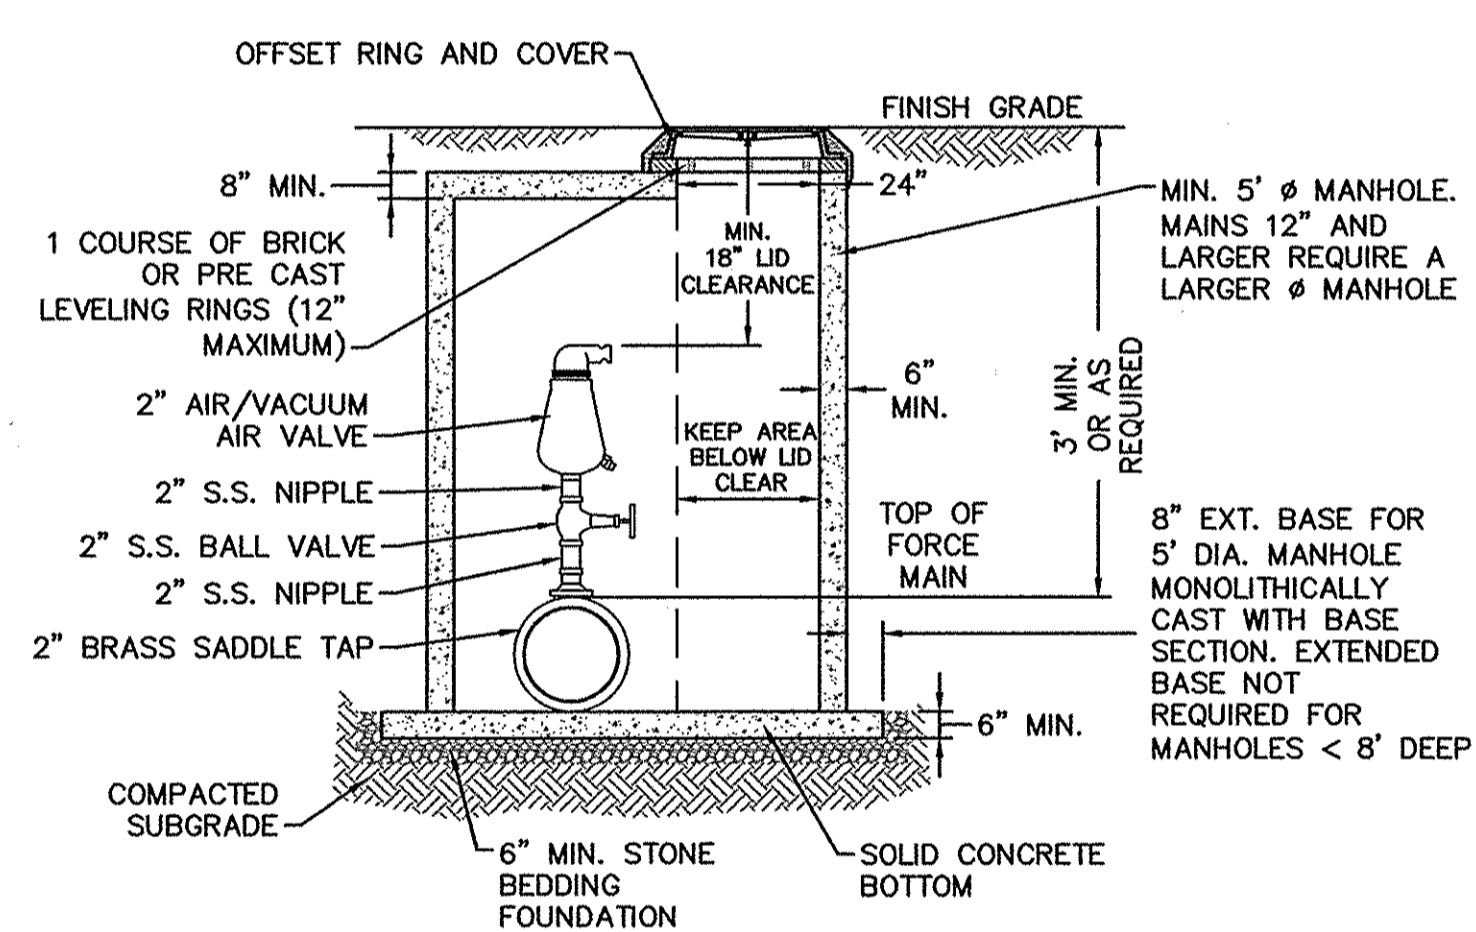
**SD-3 DROP MANHOLE**  
NOT TO SCALE

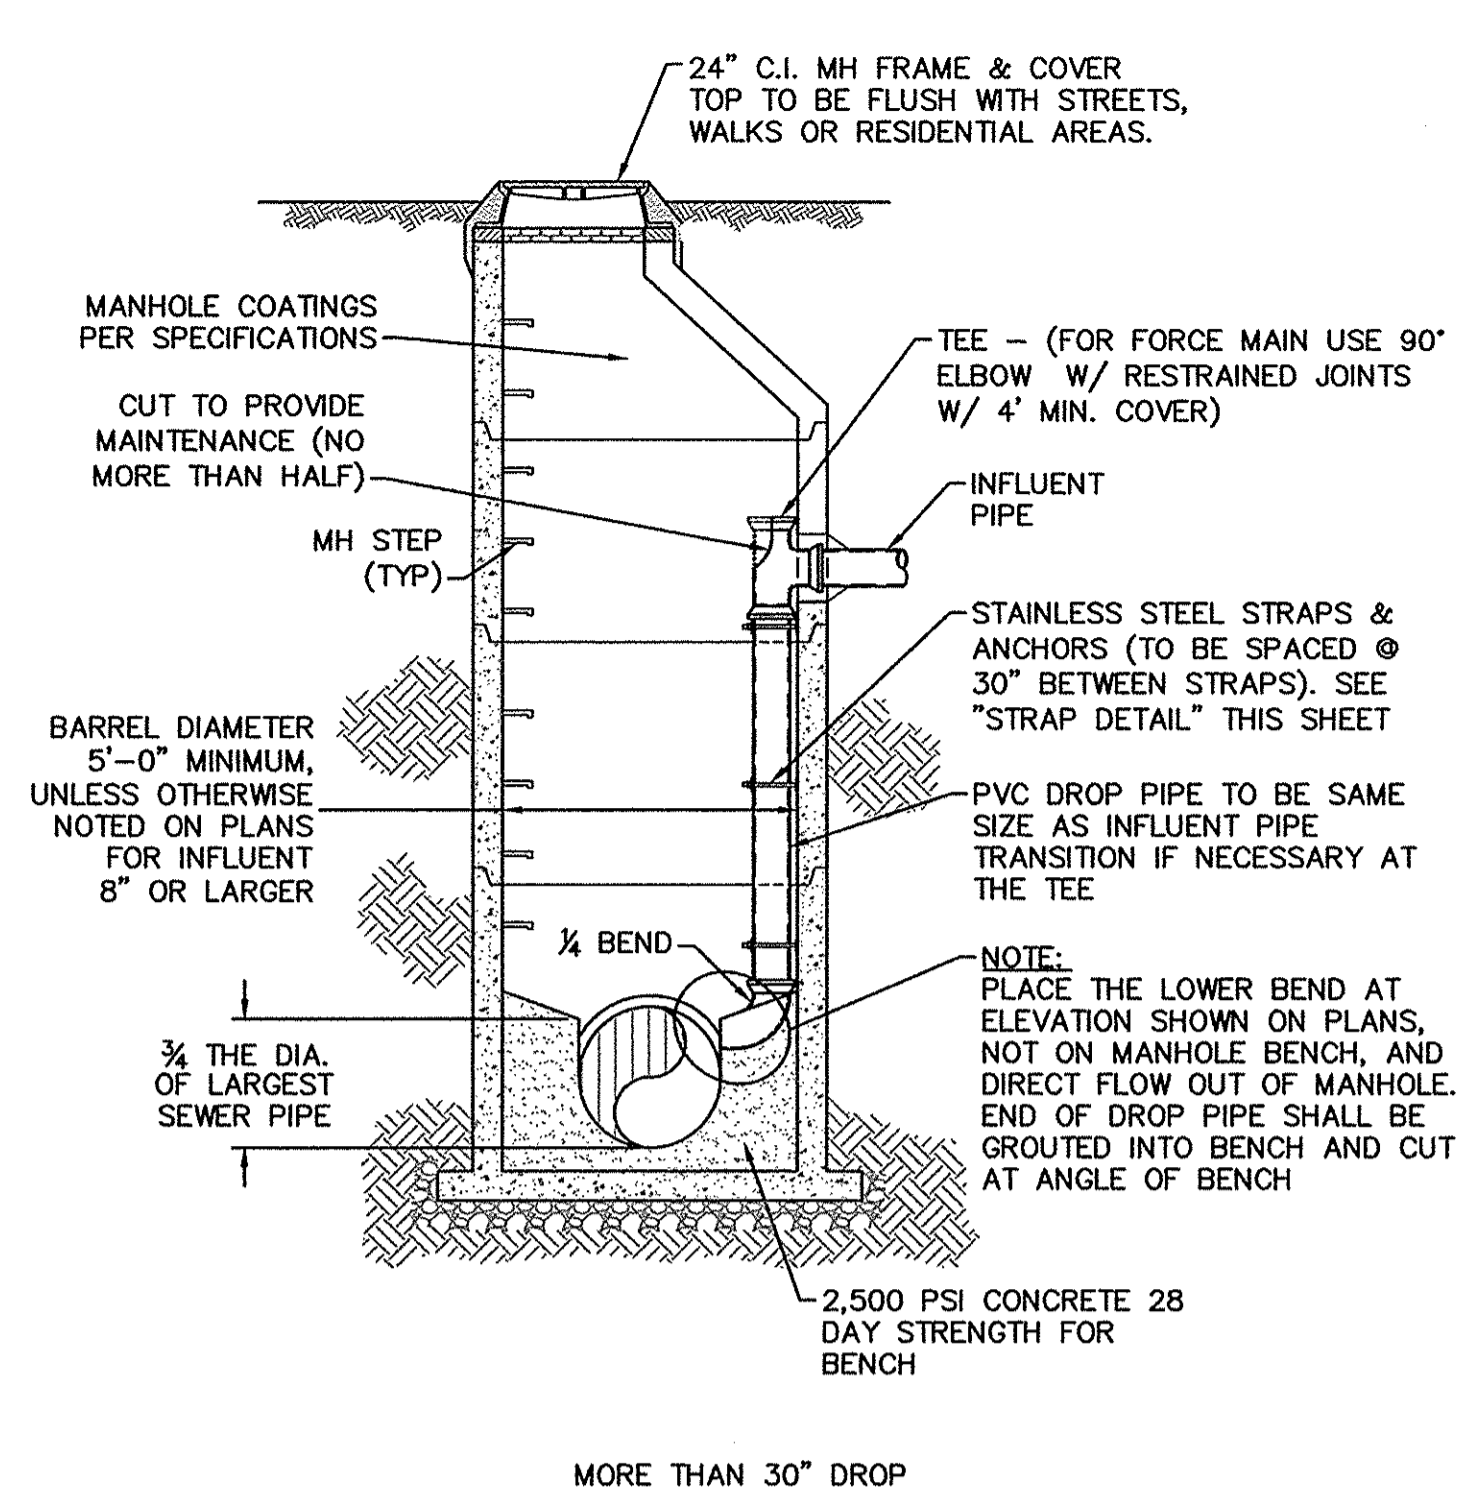

**SD-4 STANDARD VENT MANHOLE**  
NOT TO SCALE

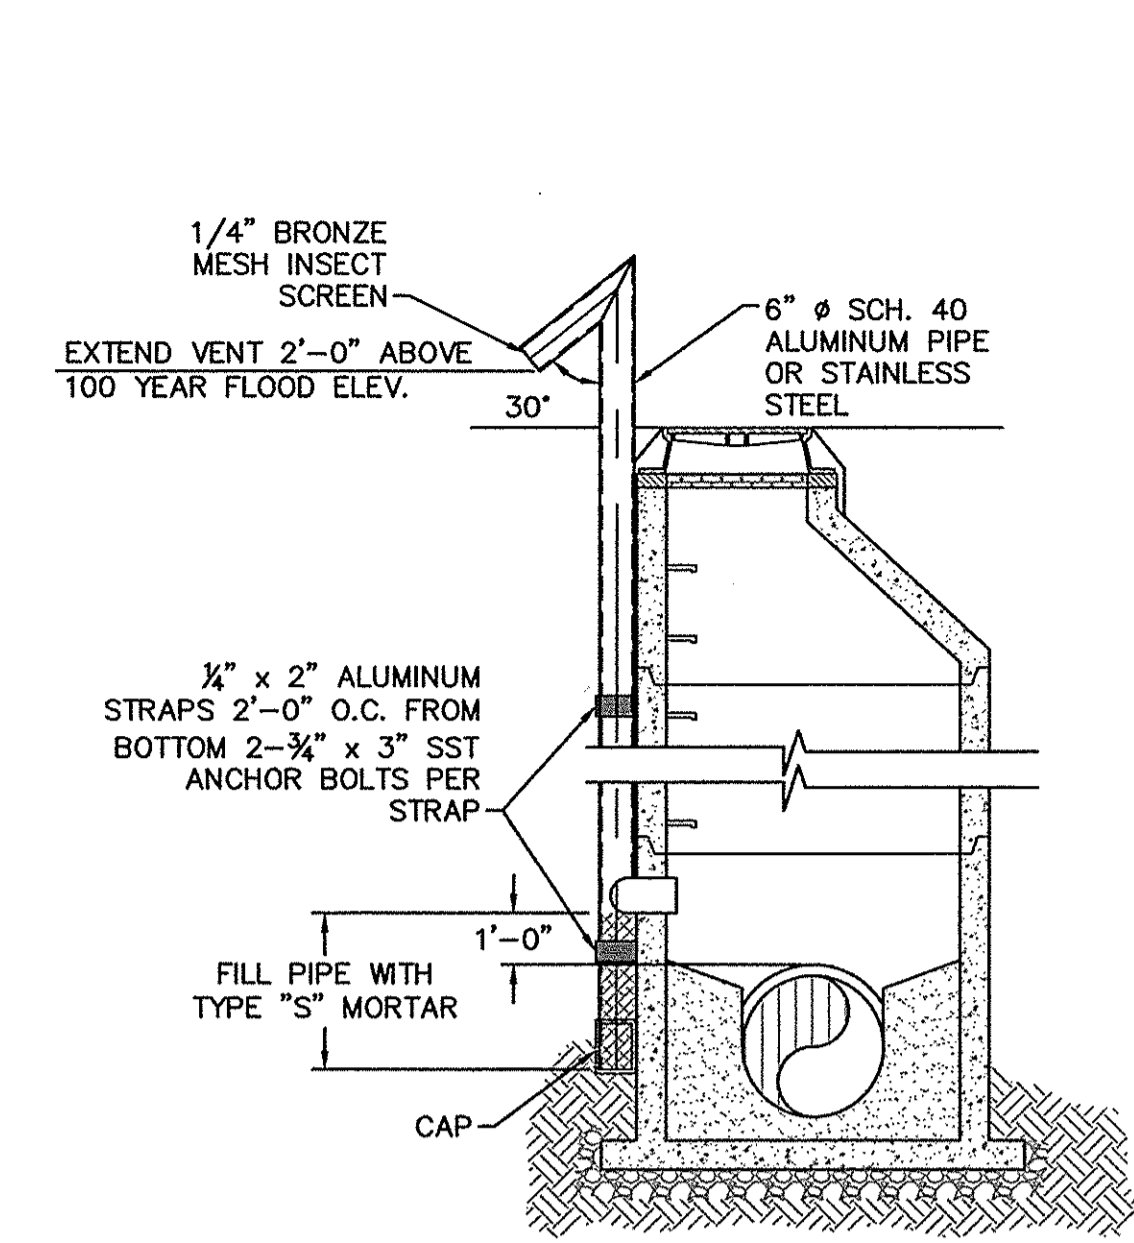


**SD-5 MANHOLE FLOOR PLAN**  
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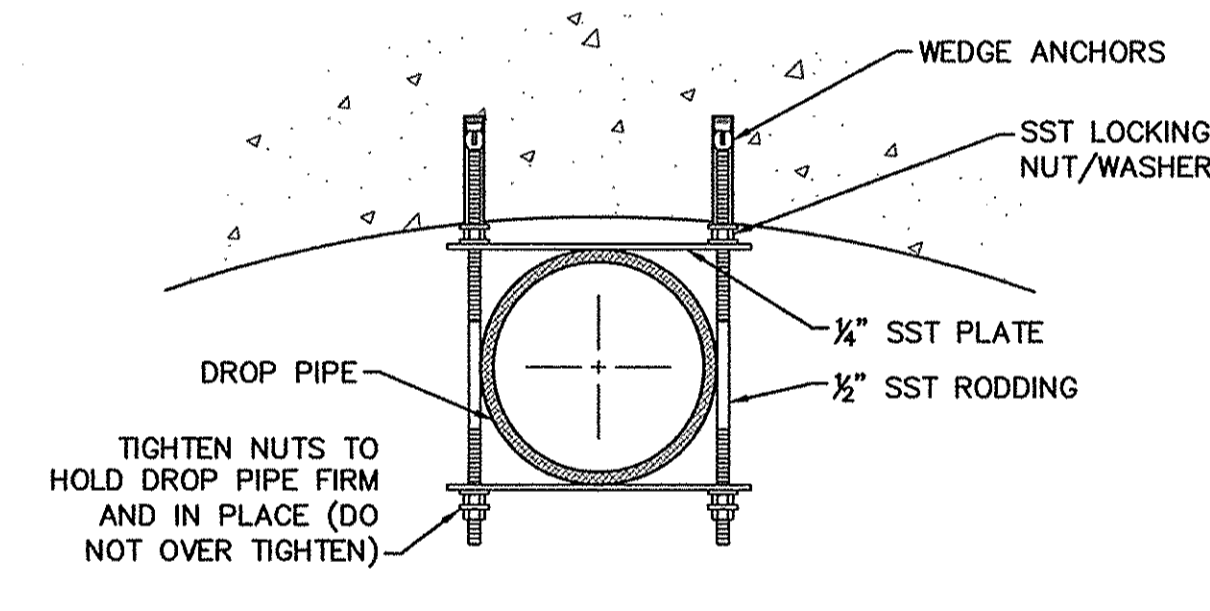


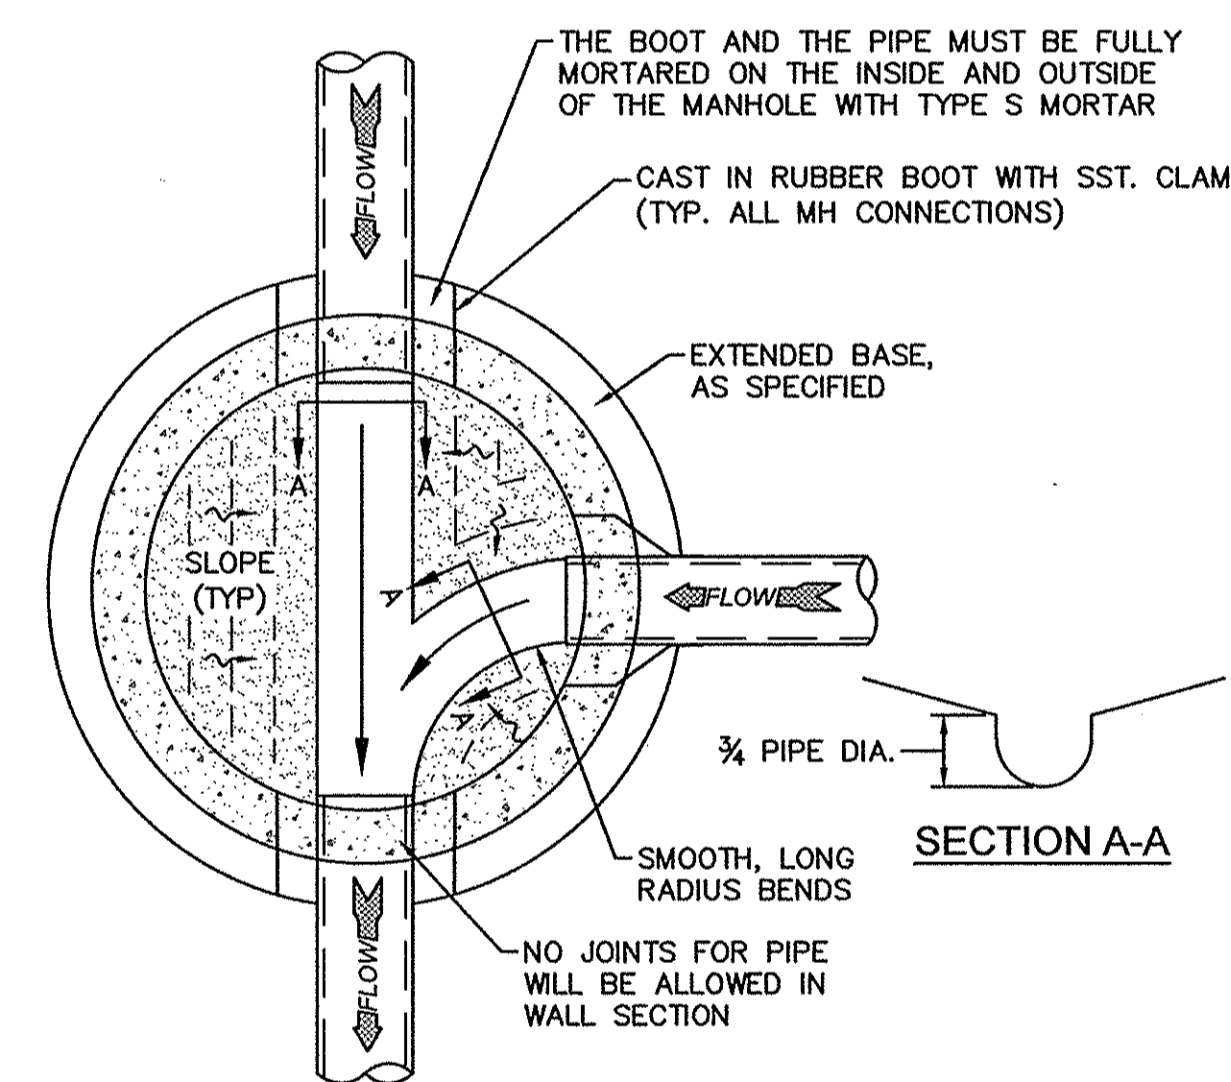**NOTES:**  
1. CONTRACTOR TO INSTALL VALVE AND MANHOLE AT SUFFICIENT DEPTH TO ALLOW FOR ACCESS.  
2. FORCE MAIN TO BE OFFSET IN MANHOLE TO KEEP AREA BELOW LID CLEAR.  
3. REFER TO SPECIFICATIONS FOR ADDITIONAL DETAILS.  
4. USE CAST IN RUBBER BOOT WITH SST. CLAMPS FOR ALL MH CONNECTIONS, INCLUDING FORCE MAIN.

**SD-6 AIR/VACUUM AND AIR RELEASE COMBINATION VALVE**  
NOT TO SCALE

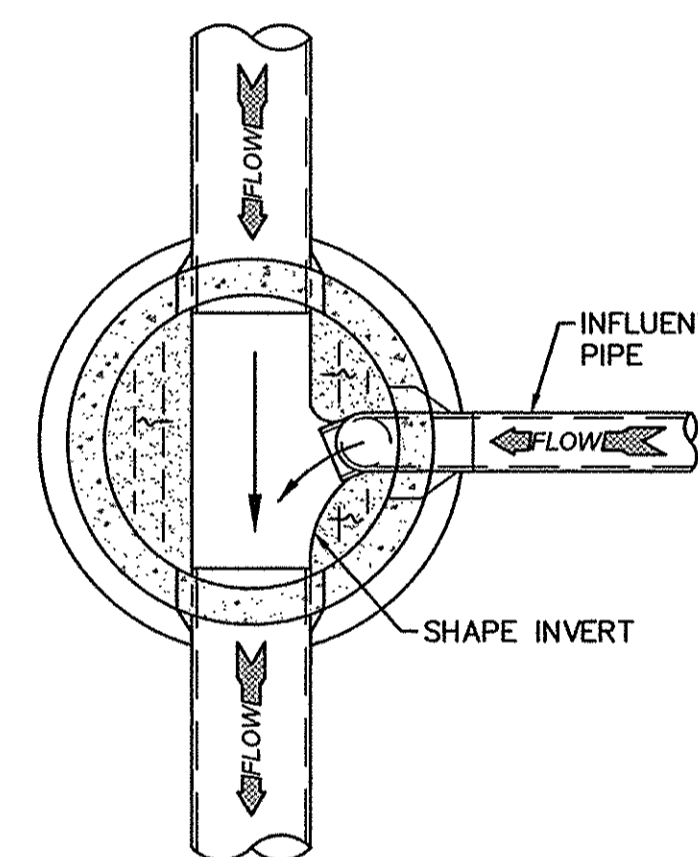

**SD-7 DROP MANHOLE FLOOR PLAN**  
NOT TO SCALE



**SD-8 STRAP DETAIL**  
NOT TO SCALE

- CAPE FEAR PUBLIC UTILITY AUTHORITY STANDARD NOTES:**
- SEWER GUARDS REQUIRED AT ALL MANHOLES. STAINLESS STEEL SEWER GUARDS REQUIRED AT MANHOLES LOCATED IN TRAFFIC AREAS.
  - WATER AND SEWER SERVICES SHALL BE PERPENDICULAR TO MAIN AND TERMINATE AT RIGHT-OF-WAY LINE. SEWER SERVICES IN CUL-DE-SACS ARE REQUIRED TO BE PERPENDICULAR, OR MUST ORIGINATE IN END OF LINE MANHOLE AND TERMINATE AT RIGHT-OF-WAY LINE.
  - ALL SERVICES TYING INTO DUCTILE IRON MAINS SHALL BE CONSTRUCTED OF CLASS 50, DIP, WITH PROTECTO 401 CERAMIC EPOXY LINING.
  - MINIMUM 10' UTILITIES EASEMENT PROVIDED ALONG THE FRONTAGE OF ALL LOTS AND AS SHOWN FOR NEW DEVELOPMENTS.
  - NO FLEXIBLE COUPLINGS SHALL BE USED.
  - ALL STAINLESS STEEL FASTENERS SHALL BE 316.
  - CLEANOUTS SHALL BE LOCATED A MINIMUM OF 12 FEET FROM ALL PROPERTY CORNERS. WATER METER BOXES ARE TO BE A MINIMUM OF 5 FEET FROM THE PROPERTY CORNER.

**SD-9 STANDARD NOTES**  
(REQUIRED ON ALL PLAN AND PROFILE SHEETS)


- GENERAL NOTES:**
- NO EXCAVATED MATERIAL SHALL BE PLACED IN ANY STREAM, DITCH OR DRAINAGE-WAY.
  - THE CONTRACTOR IS RESPONSIBLE FOR LOCATING ALL UNDERGROUND UTILITIES BEFORE ANY CONSTRUCTION BEGINS.
  - THE CONTRACTOR IS RESPONSIBLE FOR TEMPORARY SEDIMENT AND EROSION CONTROL MEASURES WHILE CONSTRUCTION IS IN PROGRESS.
  - THE CONTRACTOR IS RESPONSIBLE FOR STABILIZATION OF ALL DISTURBED AREAS.
  - THE CONTRACTOR IS RESPONSIBLE FOR LAY DOWN AND STOCKPILE AREAS (TO ARRANGE AND ENSURE COMPLIANCE WITH ALL LOCAL AND STATE REGULATIONS).

**THE DETAILS SHOWN HEREON SUPERCEDE CFPWA WRITTEN TECHNICAL SPECIFICATIONS VERSIONS 1.00 - 1.04**

THESE DETAILS ARE A WORK PRODUCT OF CFPWA FOR SEWER SYSTEM DESIGN AND CONSTRUCTION AND HAVE BEEN REVIEWED AND APPROVED FOR CONTENT AND GENERAL CONFORMANCE WITH THE SEWER DESIGN FOR THIS PROJECT.

REV:	DESCRIPTION:	DATE:
1	AIR / VACUUM AND AIR RELEASE COMBINATION VALVE REVISED	10/26/12
2	STANDARD SEWER NOTE #6 REVISED	12/10/12
3	REVISED STANDARD VENT MANHOLE TO EXTEND VENT 2'-0" ABOVE 100 YR FLOOD	11/20/14
4	Revised Multiple Details	02/15/16


**CFPUA SANITARY SEWER**

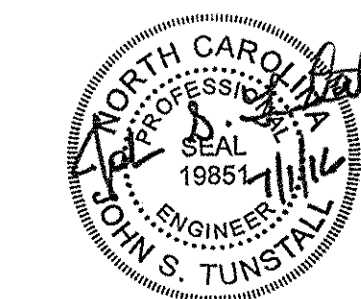


**STANDARD DETAILS**

**CAPE FEAR PUBLIC UTILITY AUTHORITY**  
235 GOVERNMENT CENTER DRIVE  
WILMINGTON, NC 28403  
OFFICE: (910)332-6560


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1/9/12  
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CFPUA  
PROJECT NO.:  
15048  
SHEET NO.:  
SSD-1

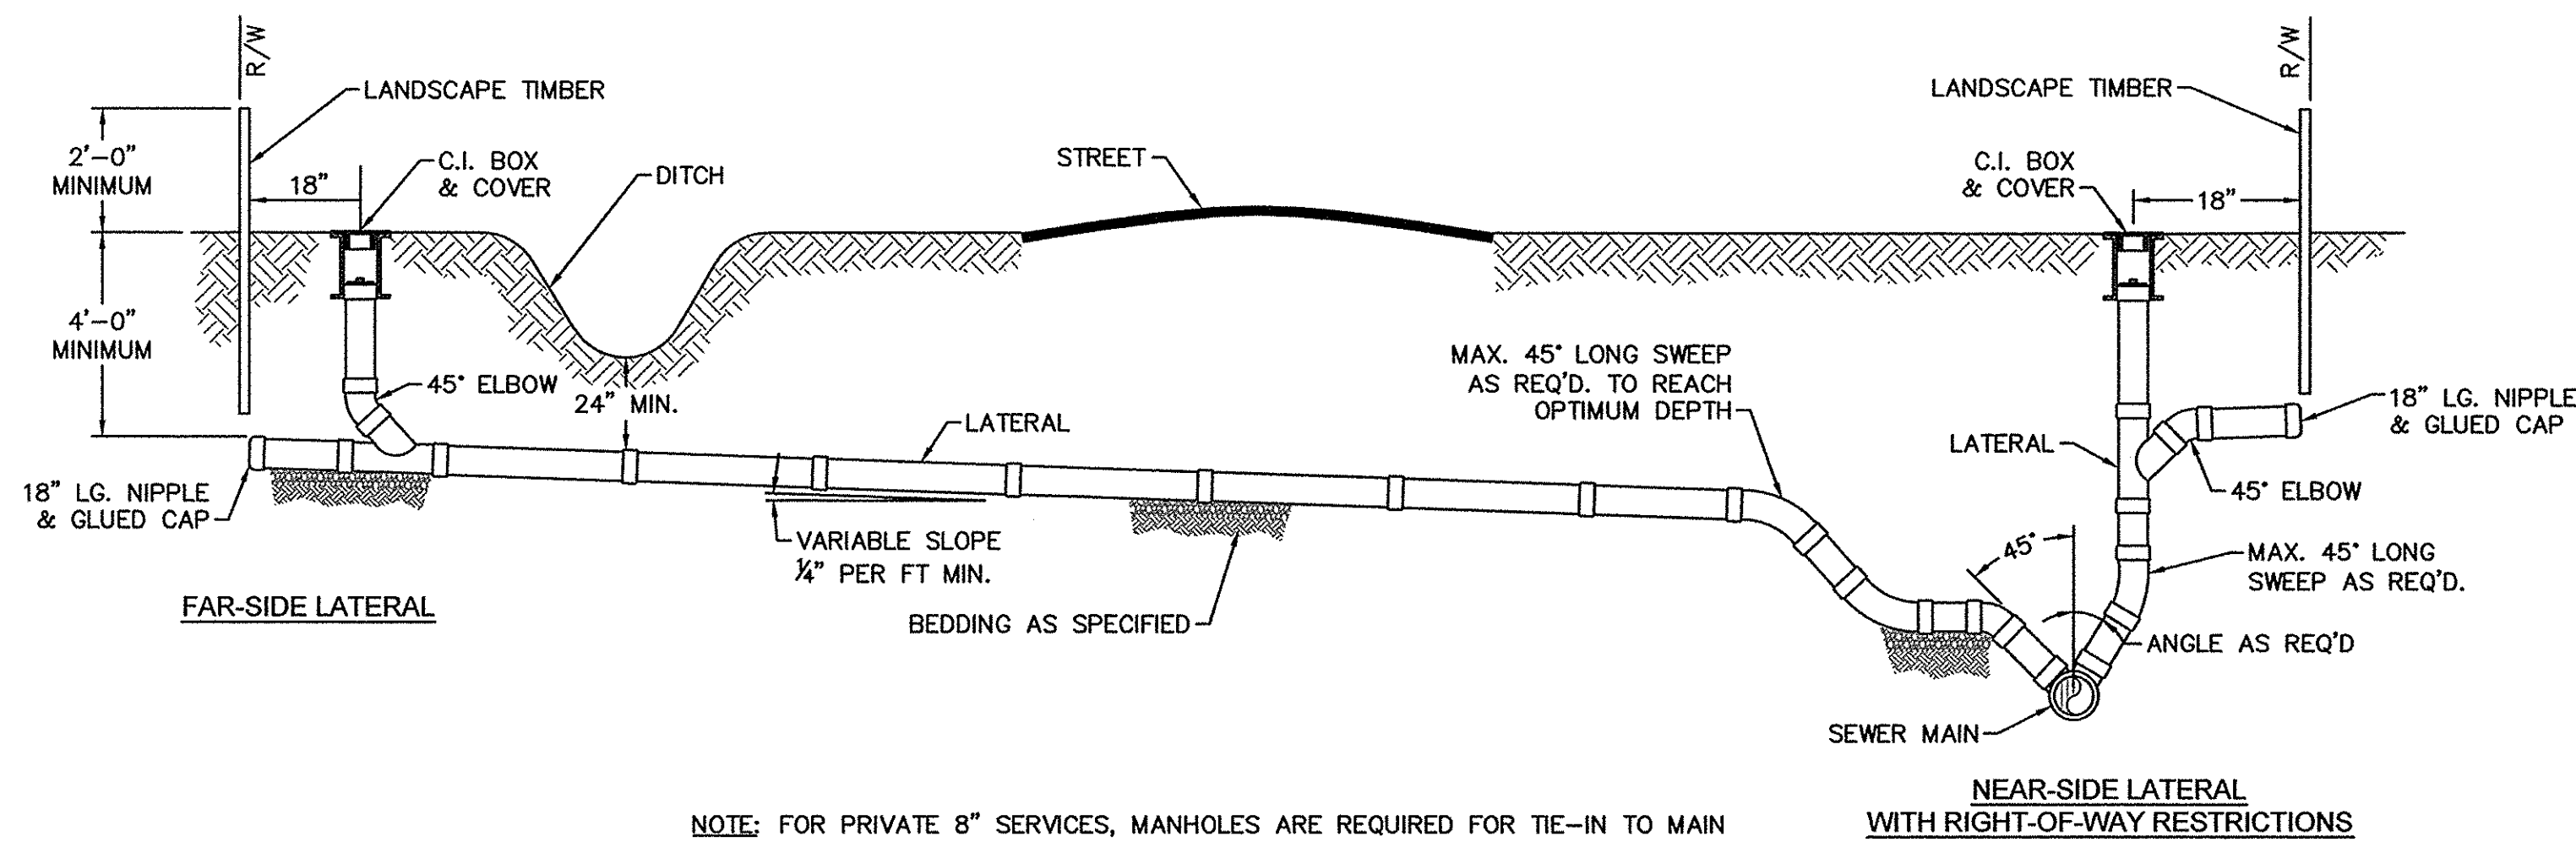


NOTE: FOR PRIVATE 8" SERVICES, MANHOLES ARE REQUIRED FOR TIE-IN TO MAIN  
**SD-19**  
**STANDARD SERVICE CONNECTION TO SANITARY SEWER**  
 NOT TO SCALE

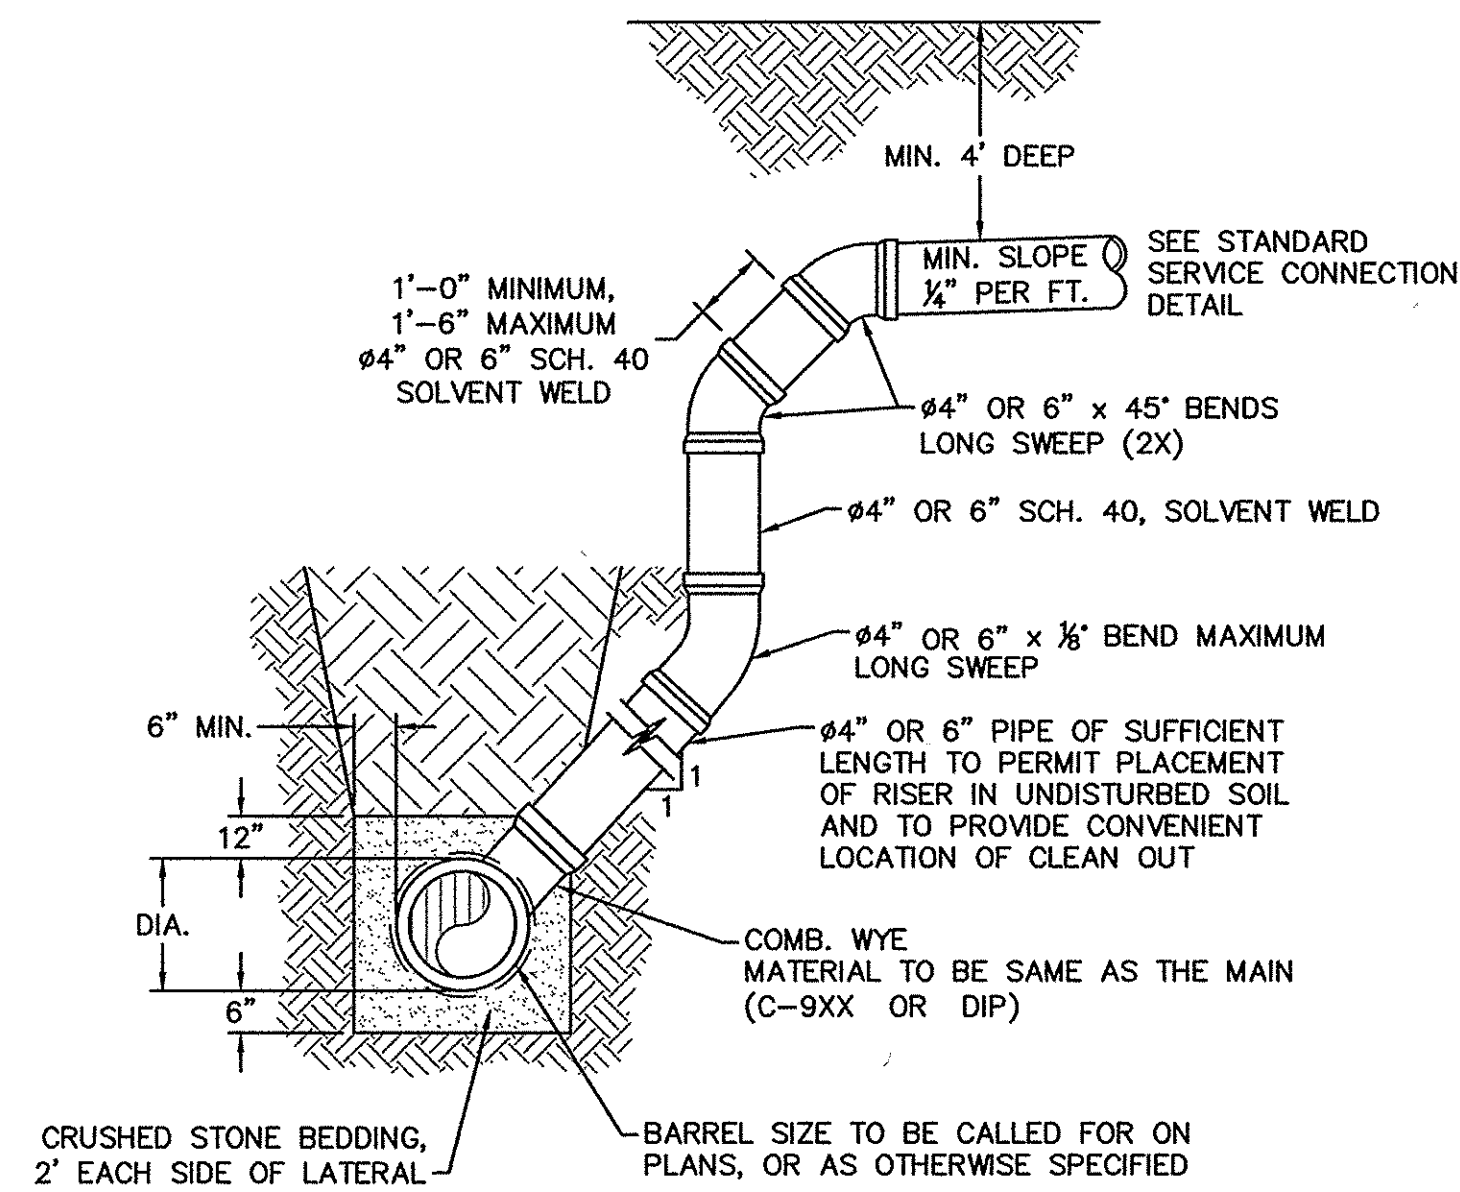


NOTE: 1. SPECIAL CARE SHALL BE TAKEN DURING BACKFILL OPERATIONS. THE RISER SHALL BE PLUMB AND TRUE AT ALL TIMES, AND REST ON FIRM, STABLE FOUNDATION.  
 2. FOR PRIVATE 8" SERVICES, MANHOLES ARE REQUIRED FOR CONNECTION TO SYSTEM AND AT THE PROPERTY LINE, WITH REQUIRED EASEMENT.  
**SD-12**  
**DEEP SERVICE LATERAL**  
 NOT TO SCALE

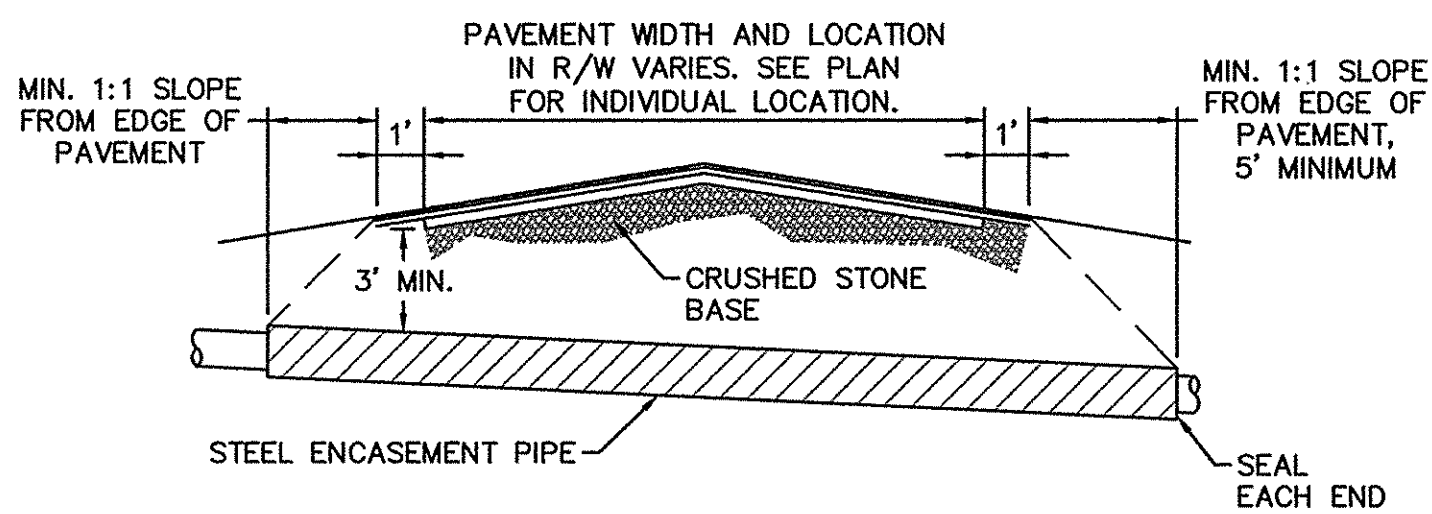


NOTE: 1. CASING WILL BE INSTALLED AT LINE AND GRADE SHOWN ON INDIVIDUAL PROFILE FOR EACH CROSSING, BORING/JACKING TO LINE AND GRADE IS REQUIRED.  
 2. TRACER WIRE SHALL BE CONTINUED THROUGH CASING.  
**SD-16**  
**TYPICAL BORING/JACKING DETAIL**  
 NOT TO SCALE

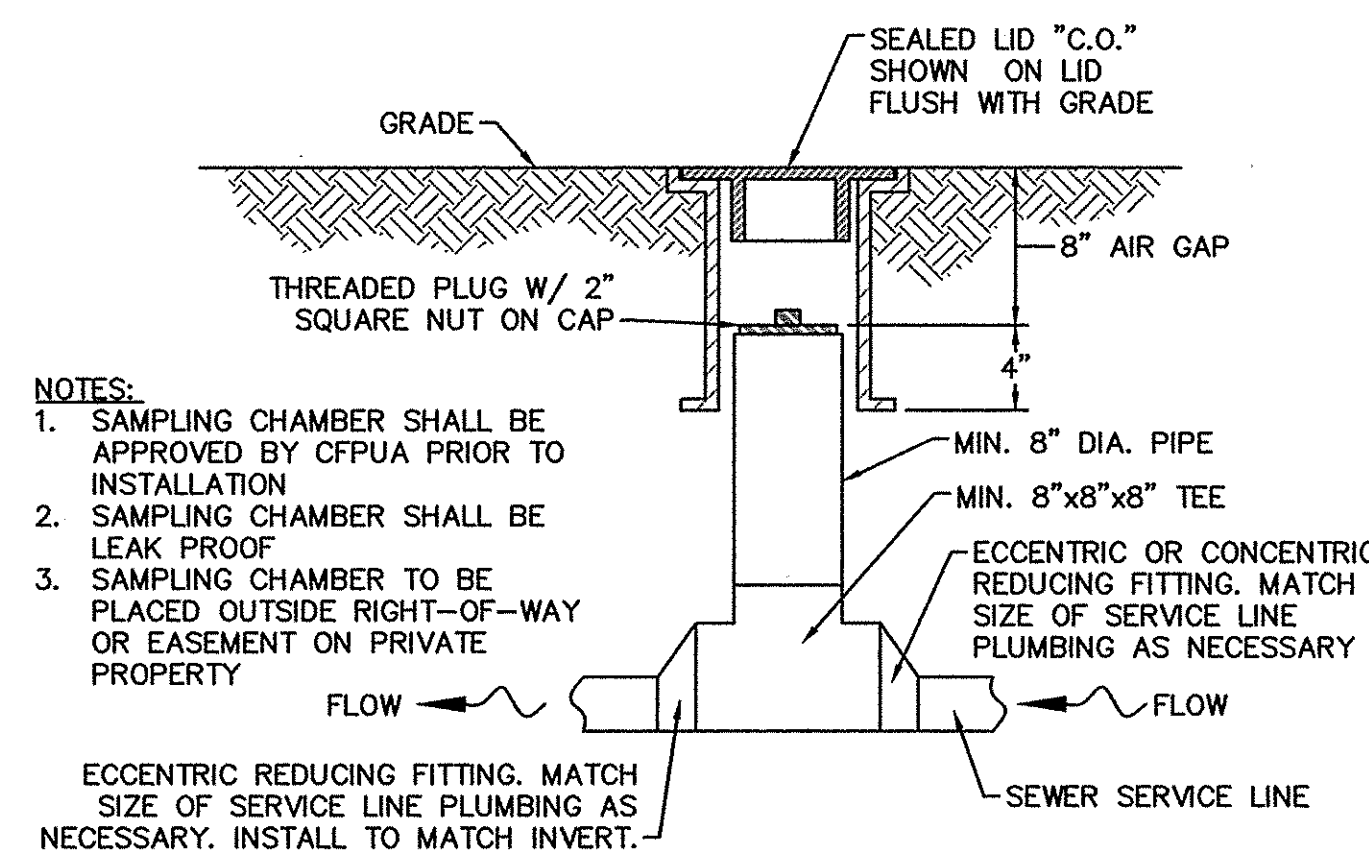


NOTE: 1. SAMPLING CHAMBER SHALL BE APPROVED BY CFPUA PRIOR TO INSTALLATION  
 2. SAMPLING CHAMBER SHALL BE LEAK PROOF  
 3. SAMPLING CHAMBER TO BE PLACED OUTSIDE RIGHT-OF-WAY OR EASEMENT ON PRIVATE PROPERTY  
**SD-13**  
**SAMPLING CHAMBER**  
 NOT TO SCALE

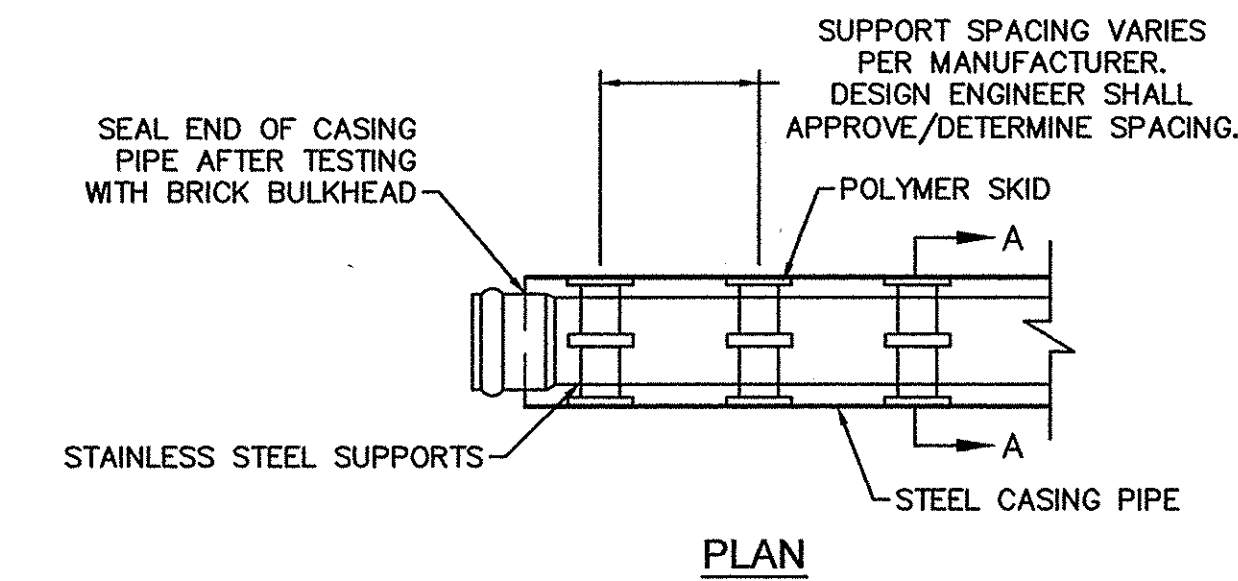


NOTE: PIPE SUPPORT TO BE PLACED TO PROVIDE PROPER SUPPORT, ALIGNMENT, AND GRADE AS SPECIFIED. CONTINUOUS SUPPORTS MAY BE USED AS ALTERNATIVE. OIL, GREASE, OR PETROLEUM PRODUCT MAY NOT BE USED AS LUBRICANT.  
**SD-17**  
**PIPE CASING SUPPORT DETAIL**  
 NOT TO SCALE

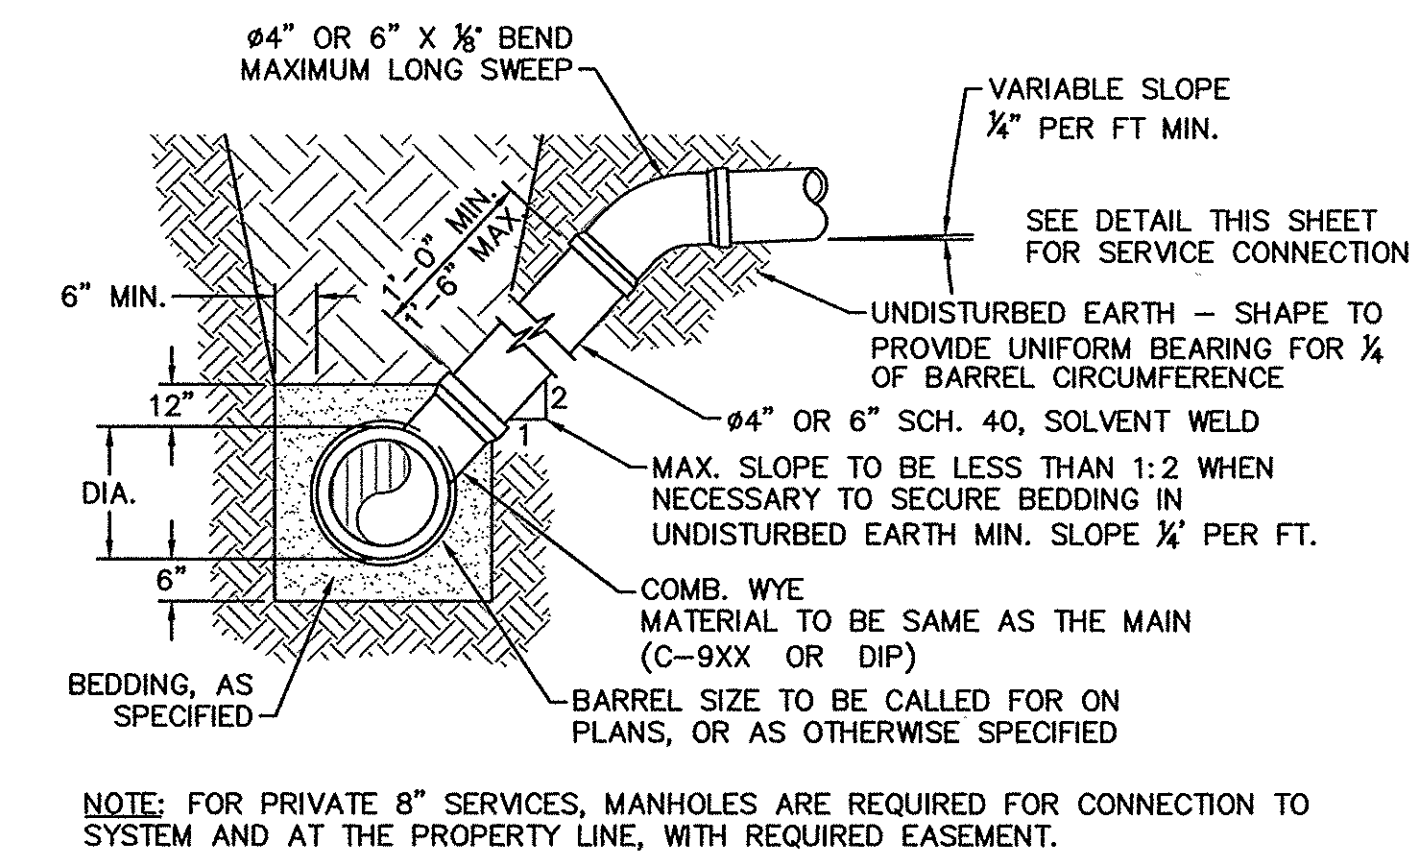


NOTE: FOR PRIVATE 8" SERVICES, MANHOLES ARE REQUIRED FOR CONNECTION TO SYSTEM AND AT THE PROPERTY LINE, WITH REQUIRED EASEMENT.  
**SD-10**  
**STANDARD SERVICE LATERAL**  
 NOT TO SCALE

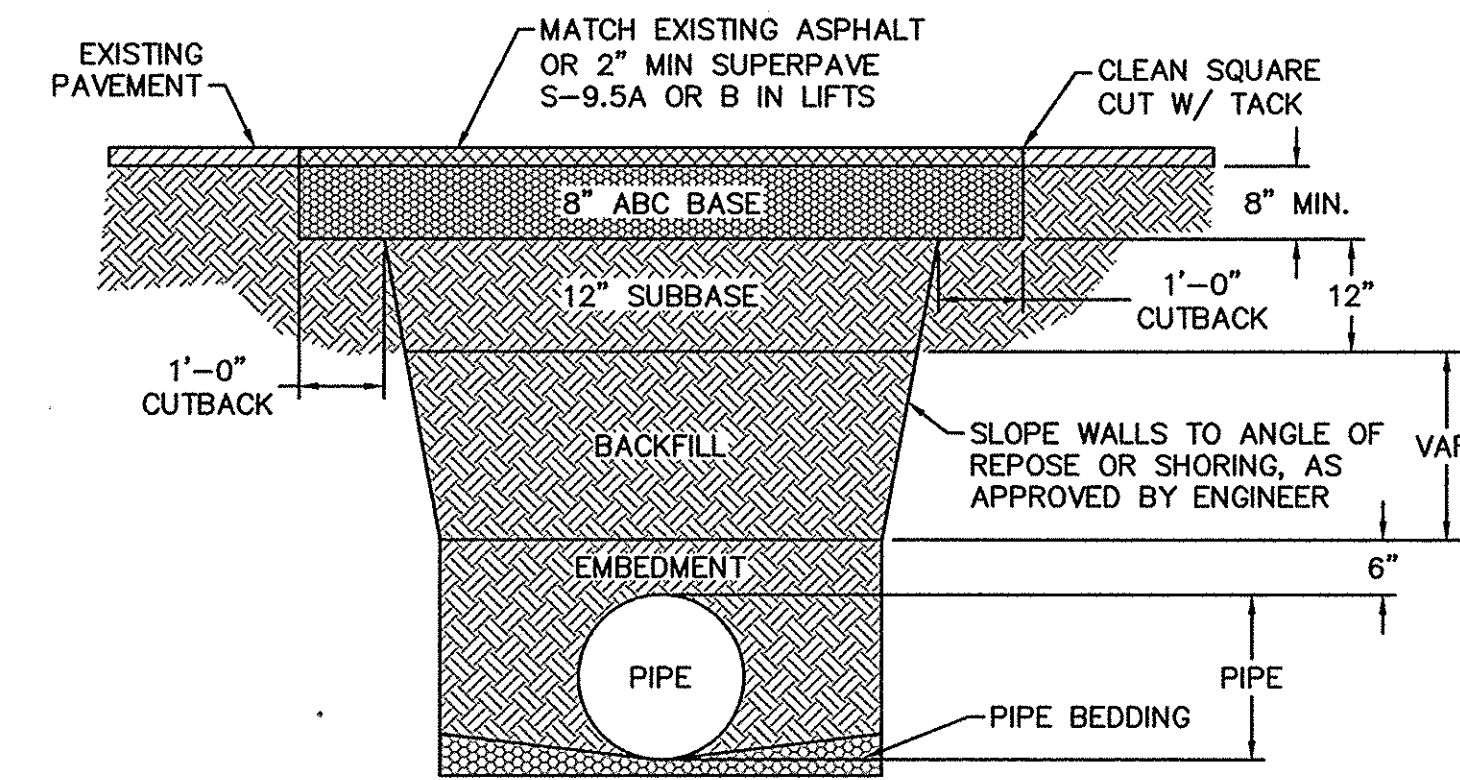

NOTE: 1. BACKFILL SHALL BE SUITABLE MATERIAL THAT IS FREE FROM HEAVY CLAY, GUMBOS, DEBRIS, ORGANICS AND LITTLE TO NO EXCESSIVE MOISTURE.  
 2. SELECT BACKFILL MAY BE SUBSTITUTED OR REQUIRED BY CITY TO ACHIEVE COMPACTION, (I.E. #57, ABC, CRUSHED LIMESTONE, CLEAN SAND, FLOWABLE FILL, ETC).  
 3. 8-INCH OF ABC BASE MATERIAL SHALL BE USED ON CITY STREETS.  
 4. BACKFILL AND BASE MATERIALS SHALL BE COMPACTED 12" MINIMUM LIFTS  
 5. SOIL SHALL BE COMPACTED BY A MECHANIZED TAMPER (I.E. JUMPING JACK). HOWEVER, VIBRATORY ROLLERS > 18" WIDTH MAY BE USED FOR LARGER EXCAVATIONS. THE PLATE TAMP METHOD SHALL NOT BE USED.  
 6. ALL APPROVED CASTINGS SHALL BE SET FLUSH TO GRADE AND SUPPORTED IF APPLICABLE.  
 7. ABC BASE AND SUBBASE COMPACTED TO 98% AND BACKFILL AND EMBEDMENT COMPACTED TO 90% AS DETERMINED BY THE MODIFIED PROCTOR AASHTO METHOD T-99.  
 8. 1-FOOT CUTBACKS OF ASPHALT SHALL BE PREPARED ON UNDISTURBED SOIL. MINIMUM ASPHALT DENSITY IS 90%.  
 (FOR PRIVATE ROADS AND PAVED AREAS; CONTRACTOR TO MEET MIN. REQUIREMENTS AS DEFINED BY RIGHT-OF-WAY OWNER FOR PUBLIC ROAD REPAIRS)  
**SD-14**  
**PAVEMENT REPAIR WHERE PIPE INSTALLED**  
 NOT TO SCALE

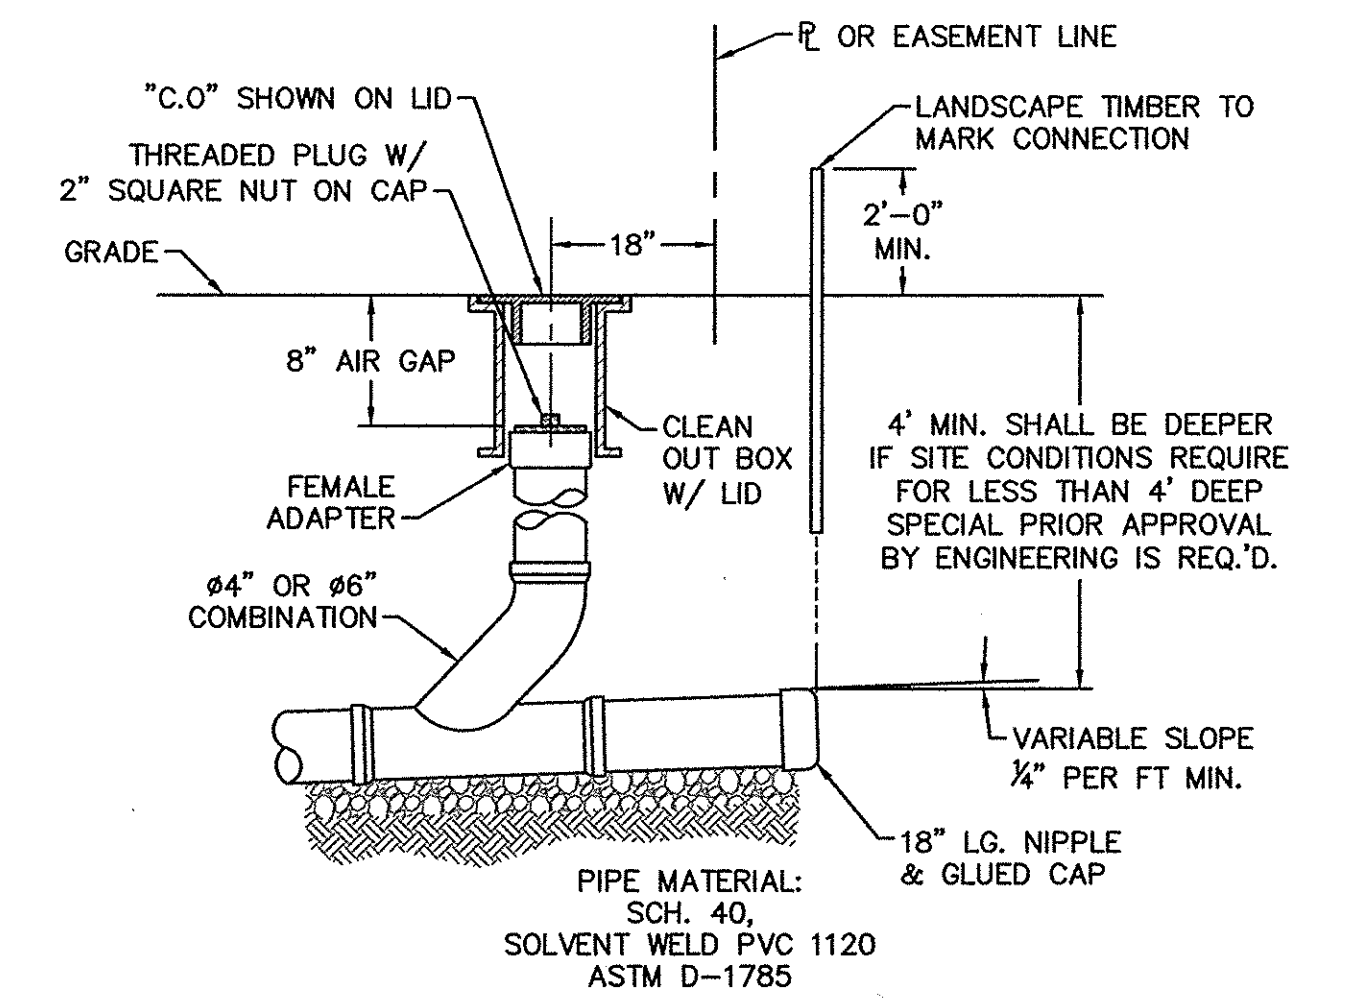

NOTE: FOR PRIVATE 8" SERVICES, MANHOLES ARE REQUIRED FOR CONNECTION TO SYSTEM AND AT THE PROPERTY LINE, WITH REQUIRED EASEMENT.  
**SD-11**  
**SERVICE CONNECTION AND CLEAN-OUT**  
 NOT TO SCALE

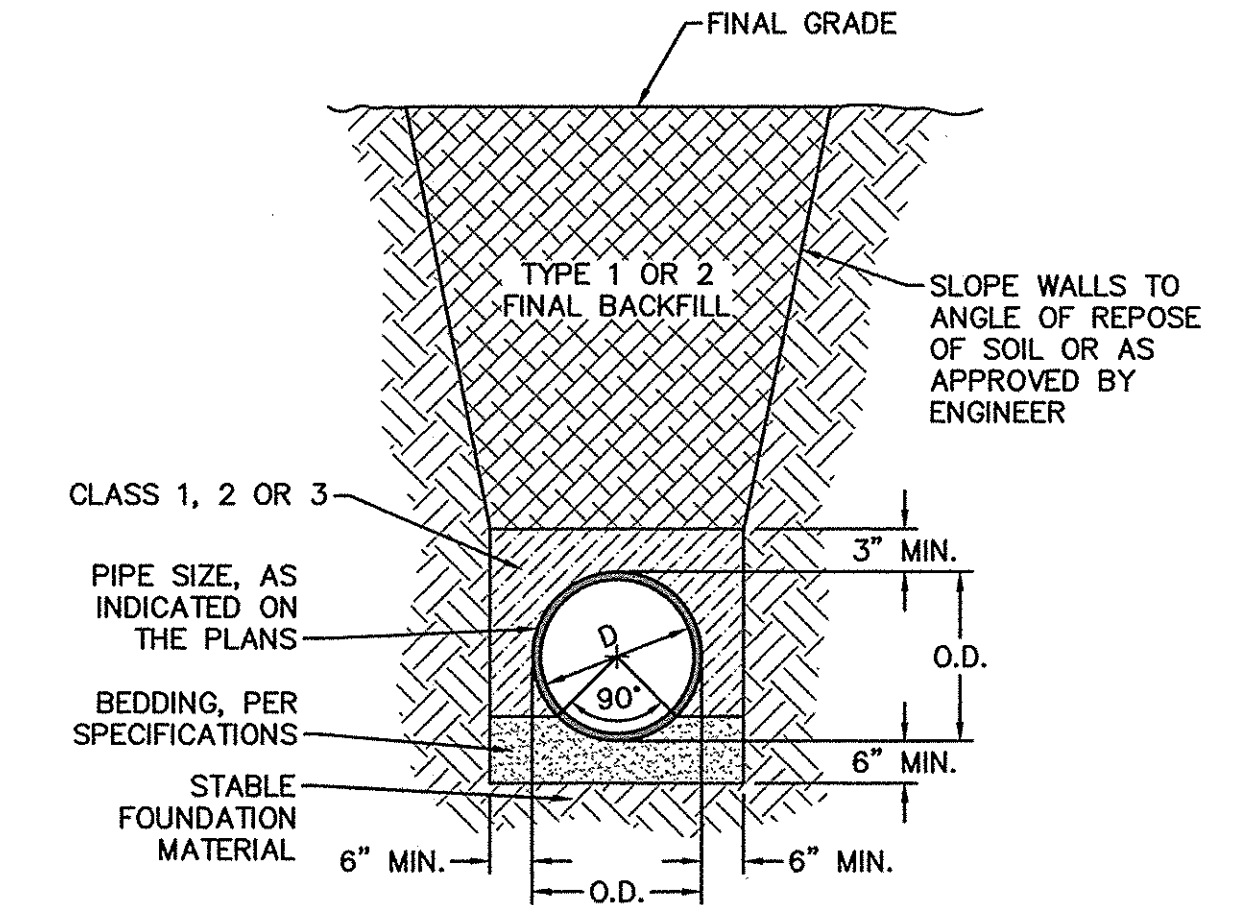

NOTE: 1. NO EXCAVATED MATERIAL SHALL BE PLACED IN ANY STREAM, DITCH OR DRAINAGE-WAY.  
 2. THE CONTRACTOR IS RESPONSIBLE FOR LOCATING ALL UNDERGROUND UTILITIES BEFORE ANY CONSTRUCTION BEGINS.  
 3. THE CONTRACTOR IS RESPONSIBLE FOR TEMPORARY SEDIMENT AND EROSION CONTROL MEASURES WHILE CONSTRUCTION IS IN PROGRESS.  
 4. THE CONTRACTOR IS RESPONSIBLE FOR STABILIZATION OF ALL DISTURBED AREAS.  
 5. THE CONTRACTOR IS RESPONSIBLE FOR LAY DOWN AND STOCKPILE AREAS (TO ARRANGE AND ENSURE COMPLIANCE WITH ALL LOCAL AND STATE REGULATIONS).  
**SD-15**  
**TYPICAL TRENCH DETAIL**  
 NOT TO SCALE

GENERAL NOTES:  
 1. NO EXCAVATED MATERIAL SHALL BE PLACED IN ANY STREAM, DITCH OR DRAINAGE-WAY.  
 2. THE CONTRACTOR IS RESPONSIBLE FOR LOCATING ALL UNDERGROUND UTILITIES BEFORE ANY CONSTRUCTION BEGINS.  
 3. THE CONTRACTOR IS RESPONSIBLE FOR TEMPORARY SEDIMENT AND EROSION CONTROL MEASURES WHILE CONSTRUCTION IS IN PROGRESS.  
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**THE DETAILS SHOWN HEREON SUPERCEDE CFPUA WRITTEN TECHNICAL SPECIFICATIONS VERSIONS 1.00 - 1.04**

THESE DETAILS ARE A WORK PRODUCT OF CFPUA FOR SEWER SYSTEM DESIGN AND CONSTRUCTION AND HAVE BEEN REVIEWED AND APPROVED FOR CONTENT AND GENERAL CONFORMANCE WITH THE SEWER DESIGN FOR THIS PROJECT.


REV.	DESCRIPTION:	DATE:
1	SAMPLING CHAMBER REVISED	10/26/12
2	Revised Multiple Details	02/15/16

**CFPUA SANITARY SEWER**


**STANDARD DETAILS**

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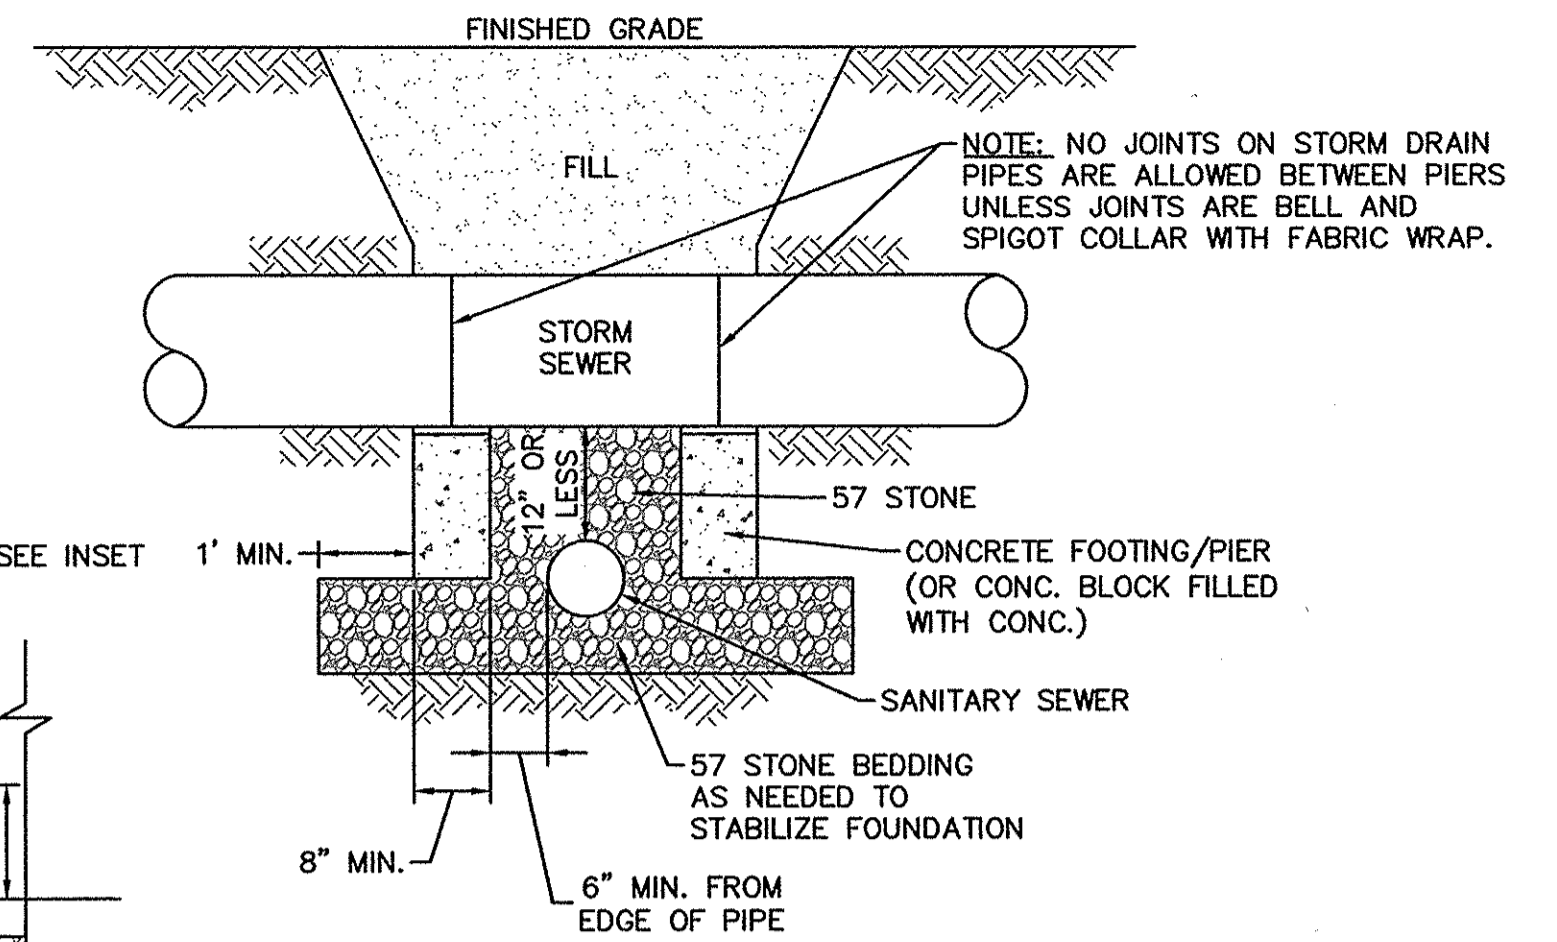
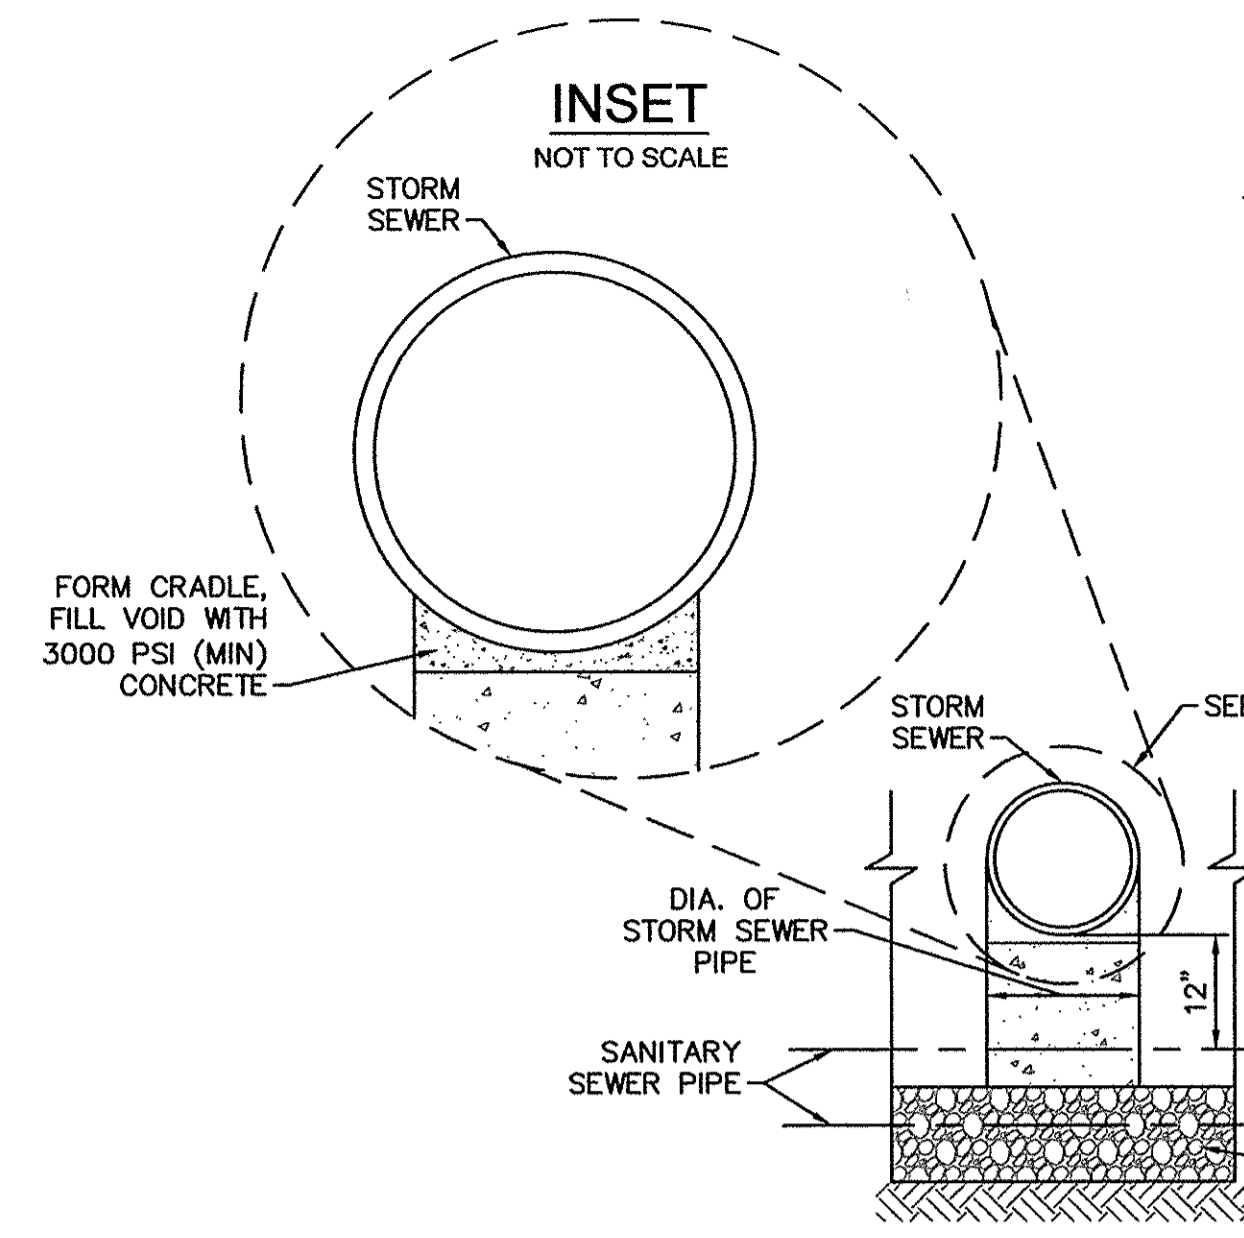
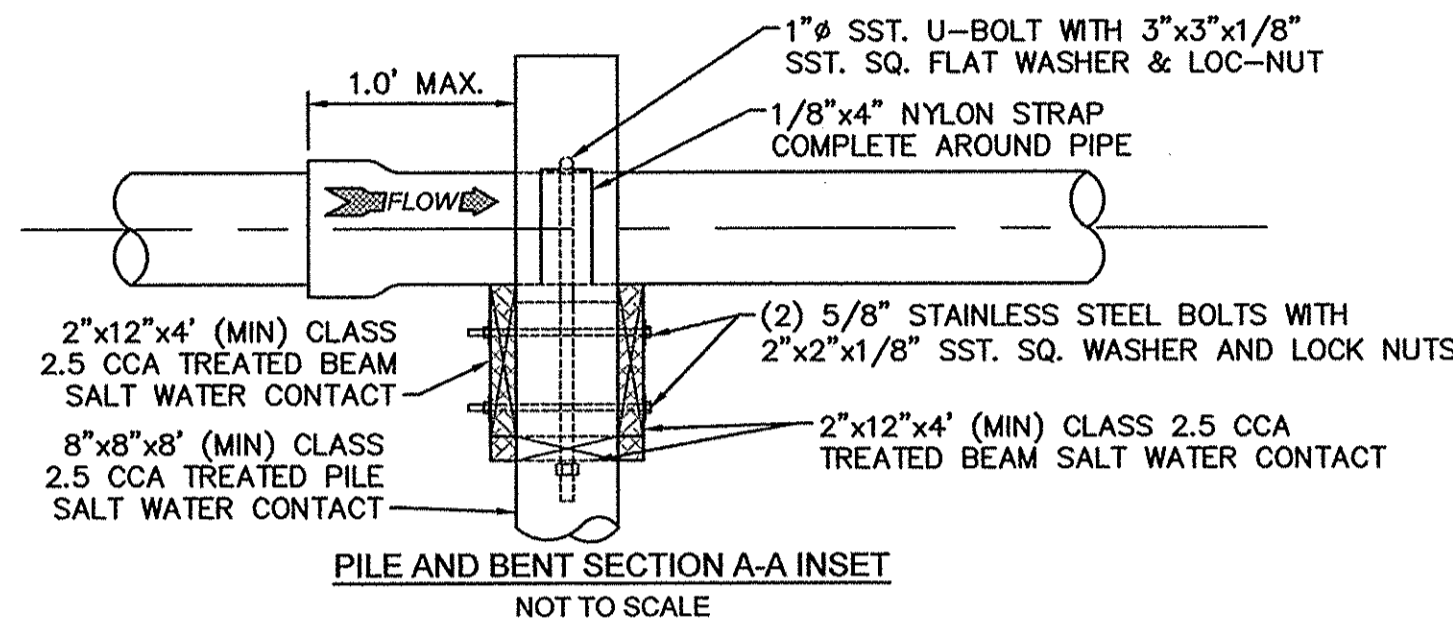
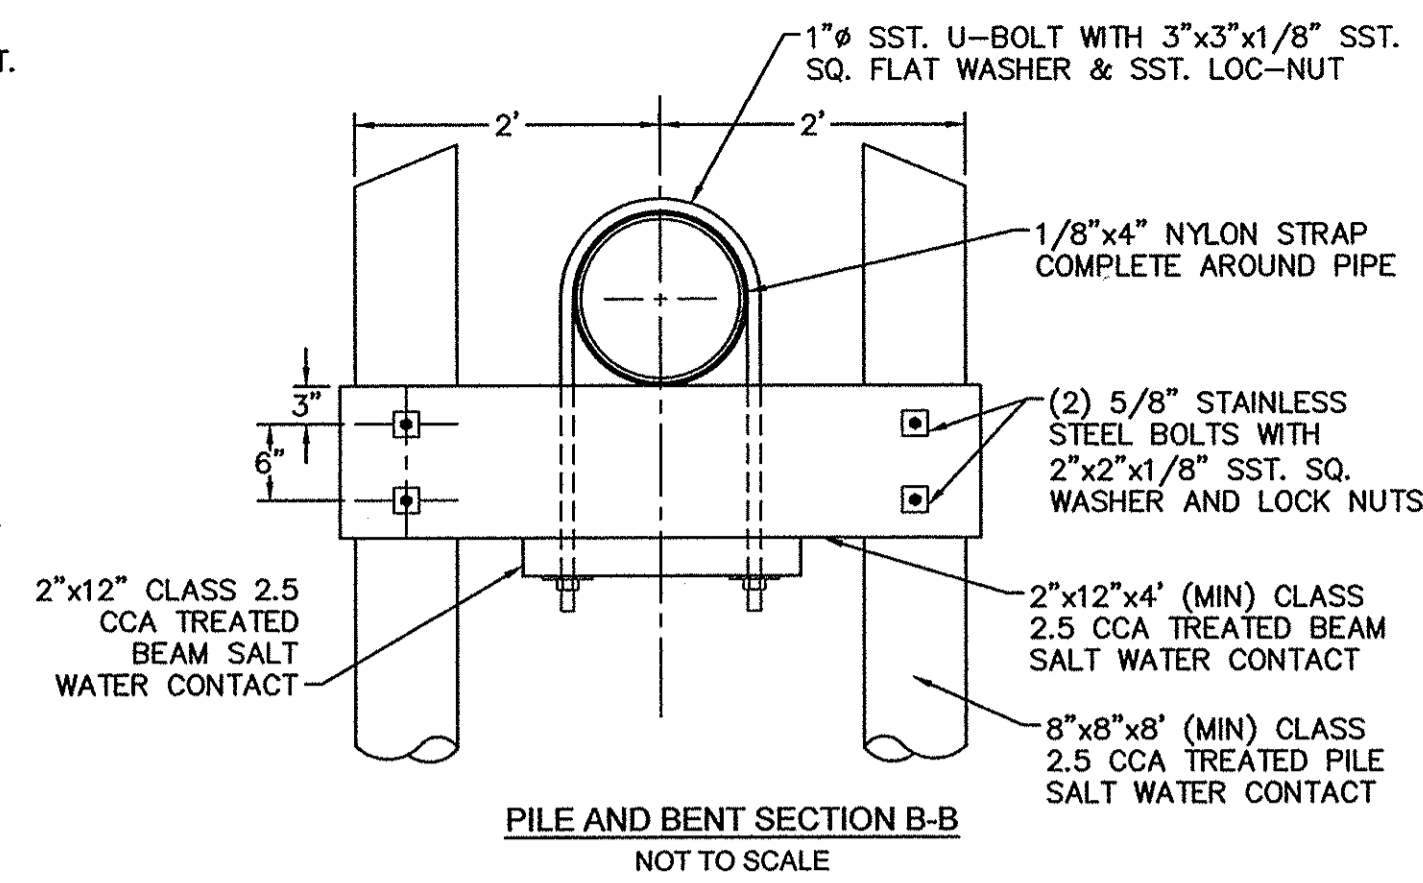
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1/9/12  
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N/A  
DRAWN BY:  
CFPUA  
CHECKED BY:  
CFPUA  
PROJECT NO.:  
15048  
SHEET NO.:  
SSD-2

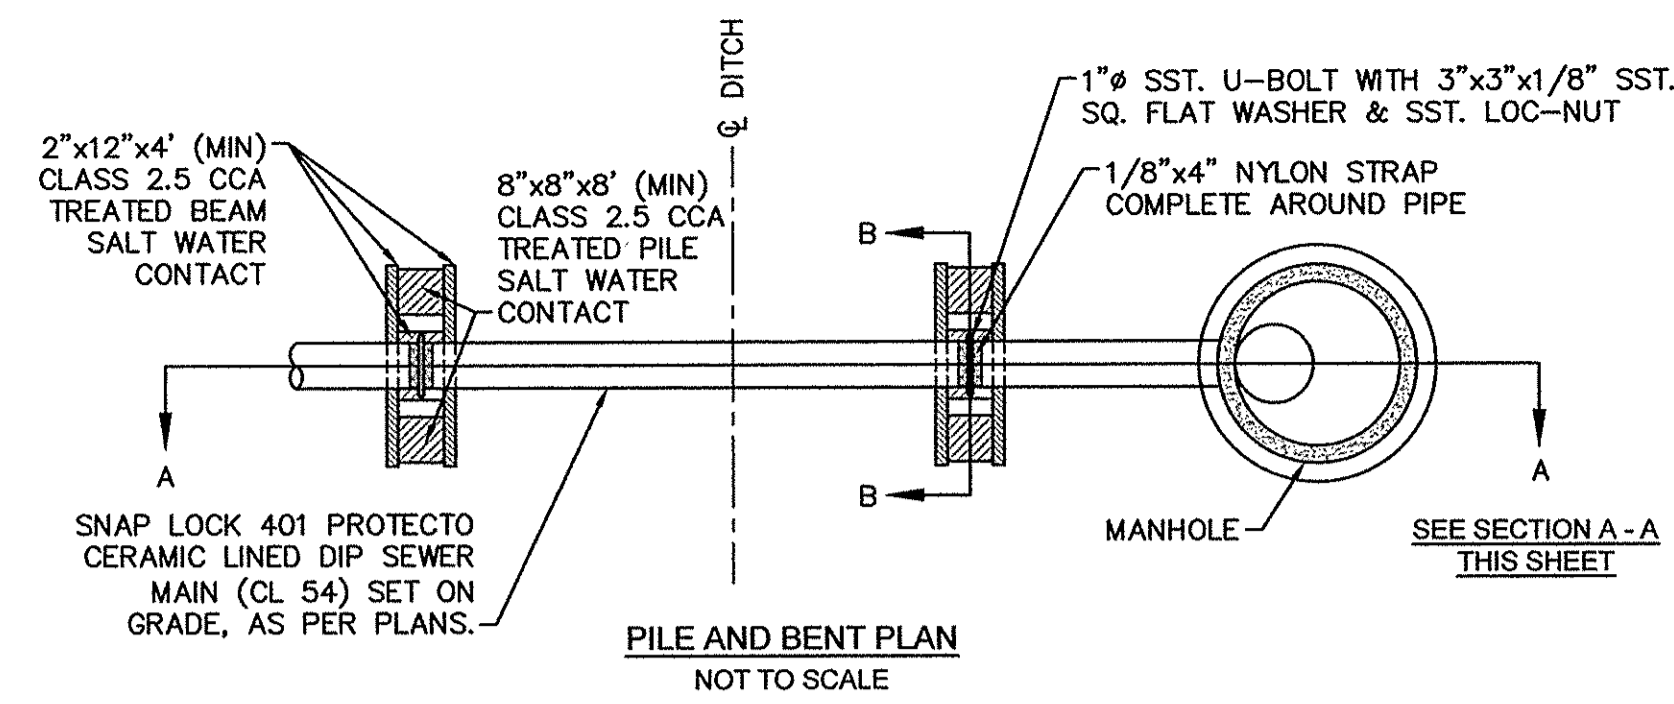

- NOTES:**
1. PILES AND PILE DRIVING SHALL CONFORM TO NCDOT STANDARD SPECIFICATIONS FOR ROADS AND STRUCTURES, JANUARY 2002, SECTIONS 445, 450, 1082-2 & 1084-2.
  2. CENTERLINE OF BOLTS TO BE A MINIMUM OF 3" FROM OUTSIDE EDGE OF TIMBER. BOLTS TO BE A MINIMUM OF 3" CENTERLINE TO CENTERLINE.
  3. ALL STAINLESS STEEL SHALL BE 316. STAINLESS STRAP TO BE COLD FORMED.
  4. PILE SHALL NOT OBSTRUCT FLOW OR CAUSE EROSION OF DITCH/STREAM BANK.
  5. MIN. CLASS 54 DIP-ENGINEER MUST DESIGN LOADING.
  6. DESIGN SHALL BE APPROVED BY CFPUA.

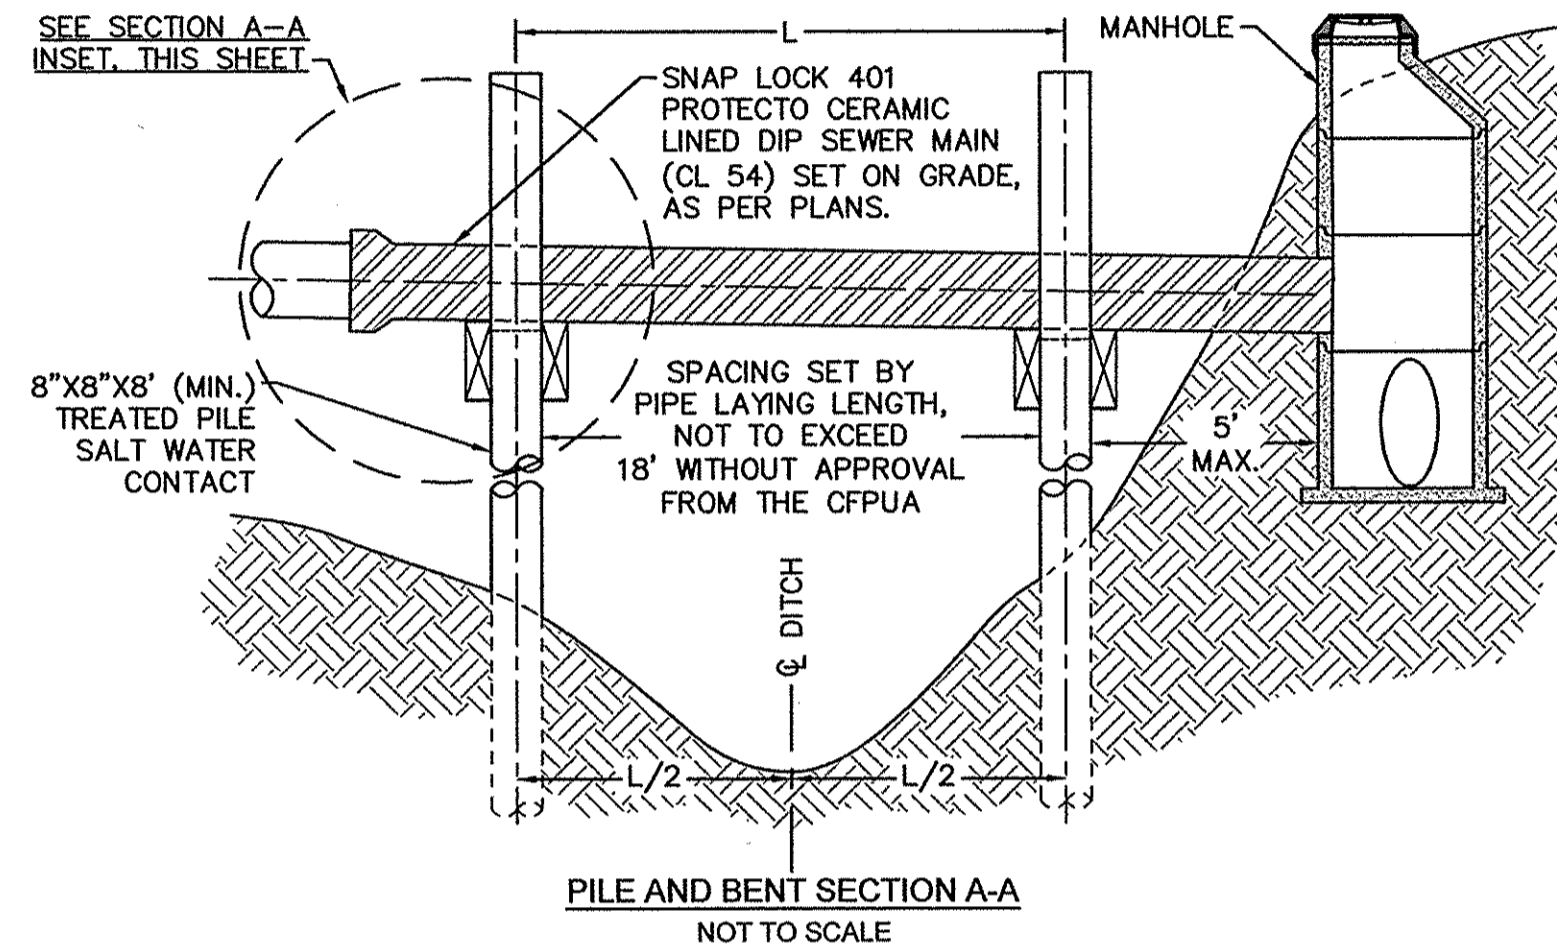


**SD-20 PILE AND BENT DETAIL**  
NOT TO SCALE



- THE FOLLOWING MUST BE FOLLOWED IN THE CASES OF GRAVITY SEWER UNDER STORM DRAIN:**
- A SEPARATION OF LESS THAN 12' BETWEEN STORM DRAIN AND GRAVITY SEWER, STORM DRAIN MUST BE BRIDGED.
  - A SEPARATION OF 12' TO LESS THAN 24' BETWEEN STORM DRAIN AND GRAVITY SEWER, GRAVITY SEWER CAN BE DIP OR STORM DRAIN CAN BE BRIDGED. (PER DWR REGULATIONS)
  - A SEPARATION OF 24" OR GREATER BETWEEN STORM DRAIN AND GRAVITY SEWER REQUIRES NO BRIDGING OR DIP.

**STRUCTURAL BRIDGING DETAIL FOR STORMWATER OVER GRAVITY SEWER INSTALLATIONS WITH LESS THAN 12" SEPARATION**


**SD-24**  
NOT TO SCALE

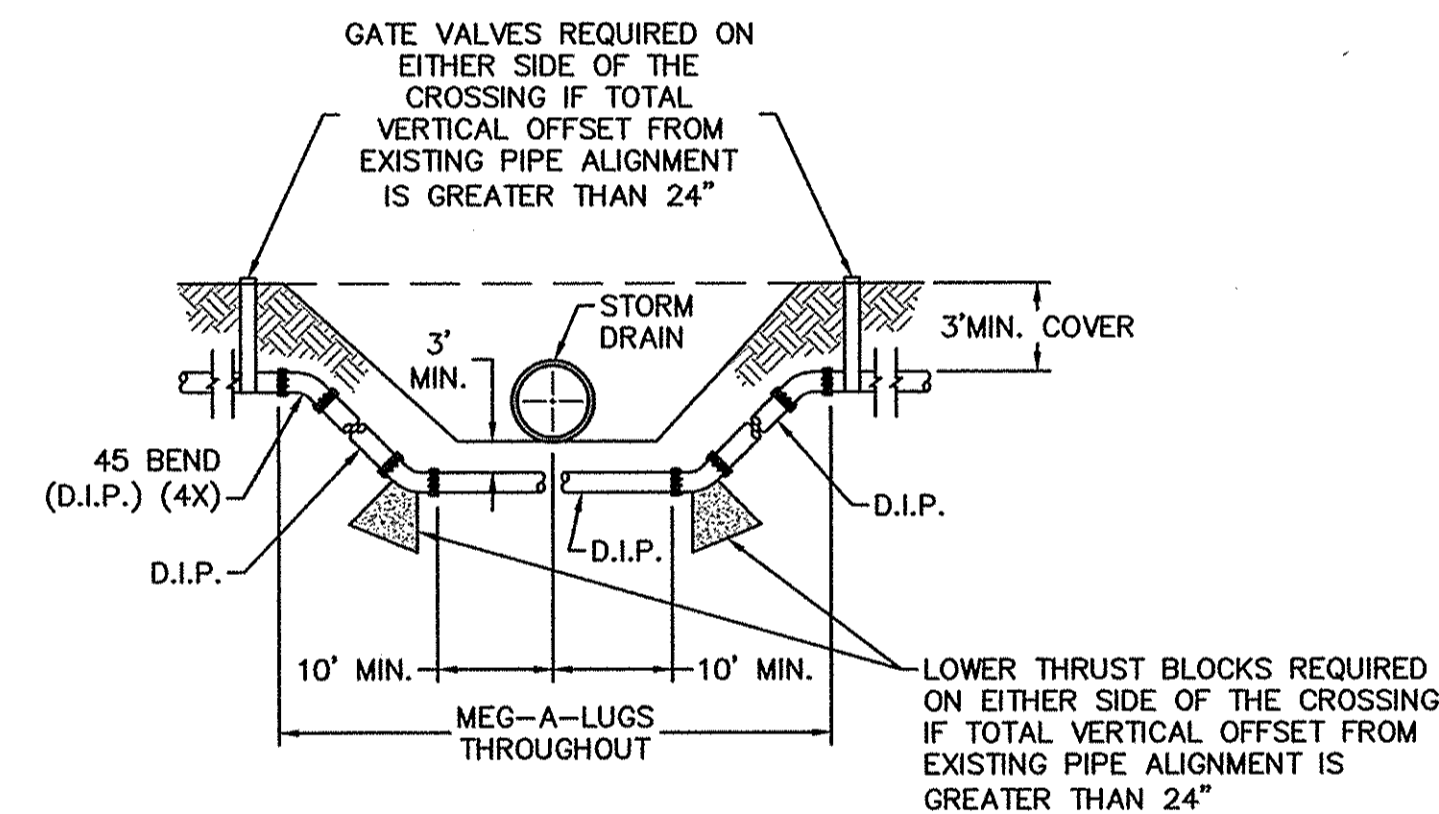

NOTE: USE D.I.P. (CL50 OR BETTER)

**FORCE MAIN DITCH AND STORM DRAIN CROSSING**

**SD-18**  
NOT TO SCALE

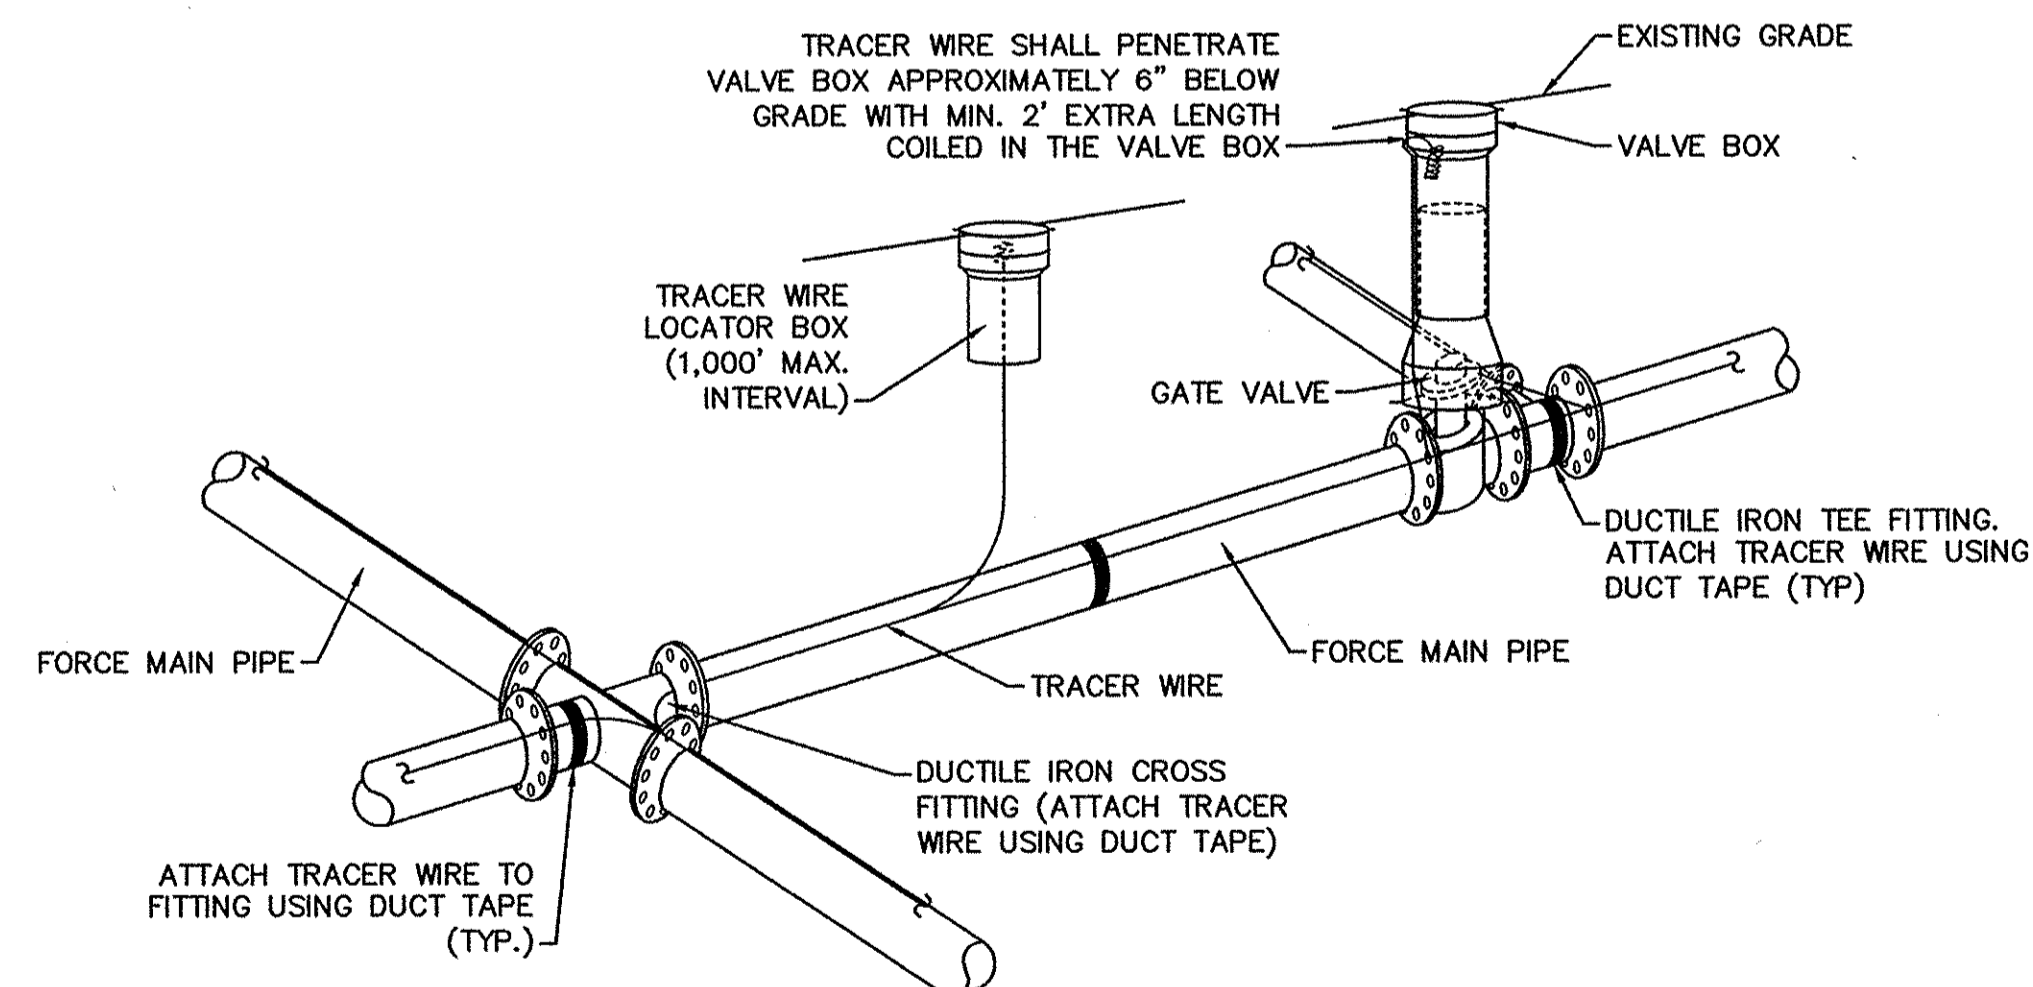

- NOTES:**
1. TRACER WIRE SHALL BE #10 COPPER SOLID CORE COPPER WIRE WITH GAS AND OIL RESISTANT INSULATION.
  2. WIRE SHALL BE STRAPPED TO ALL PVC FORCE MAIN PIPING WITH DUCT TAPE AT 12 FOOT INTERVALS ALONG THE PIPE.
  3. SECURE WIRE TO ALL TEE AND CROSS FITTINGS WITH DUCT TAPE.
  4. ALL SPLICES IN THE WIRE SHALL BE MADE WITH 3M DBR DIRECT BURY SPLICE KIT AN UNDERGROUND RATED, WATERTIGHT, AND APPROVED SPLICE CONNECTOR OR APPROVED EQUAL.

**SD-21 TRACER WIRE DETAIL**  
NOT TO SCALE

- GENERAL NOTES:**
1. NO EXCAVATED MATERIAL SHALL BE PLACED IN ANY STREAM, DITCH OR DRAINAGE-WAY.
  2. THE CONTRACTOR IS RESPONSIBLE FOR LOCATING ALL UNDERGROUND UTILITIES BEFORE ANY CONSTRUCTION BEGINS.
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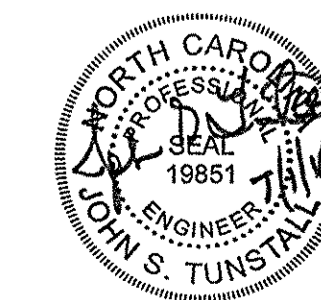
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REV.	DESCRIPTION:	DATE:
1	ADDED NOTES TO THE STRUCTURAL BRIDGING DETAIL	03/11/15
2	Revised Tracer Wire Detail	10/20/15
3	Revised Force Main Ditch and Storm Drain Crossing Detail	02/15/16

**CFPUA SANITARY SEWER**

**STANDARD DETAILS**



**CAPE FEAR PUBLIC UTILITY AUTHORITY**  
235 GOVERNMENT CENTER DRIVE  
WILMINGTON, NC 28403  
OFFICE: (910)332-6560  
Stewardship. Sustainability. Service.

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CFPUA  
PROJECT NO.:  
15048

**SHEET NO:**  
**SSD-3**